RENOVATIONS TO


MEMORIAL PARK RECREATION CENTER

OWNER: MBC PARKS AND RECREATION

150 WILLIE SMOKIE GLOVER DRIVE,
MACON, GA 31201


FACILITY: MEMORIAL PARK RECREATION CENTER 2465 2ND ST, MACON, GA 31206



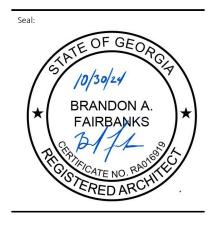

2465 2ND ST, MACON, GA 31206

30 OCTOBER 2024 - ISSUED FOR PERMIT

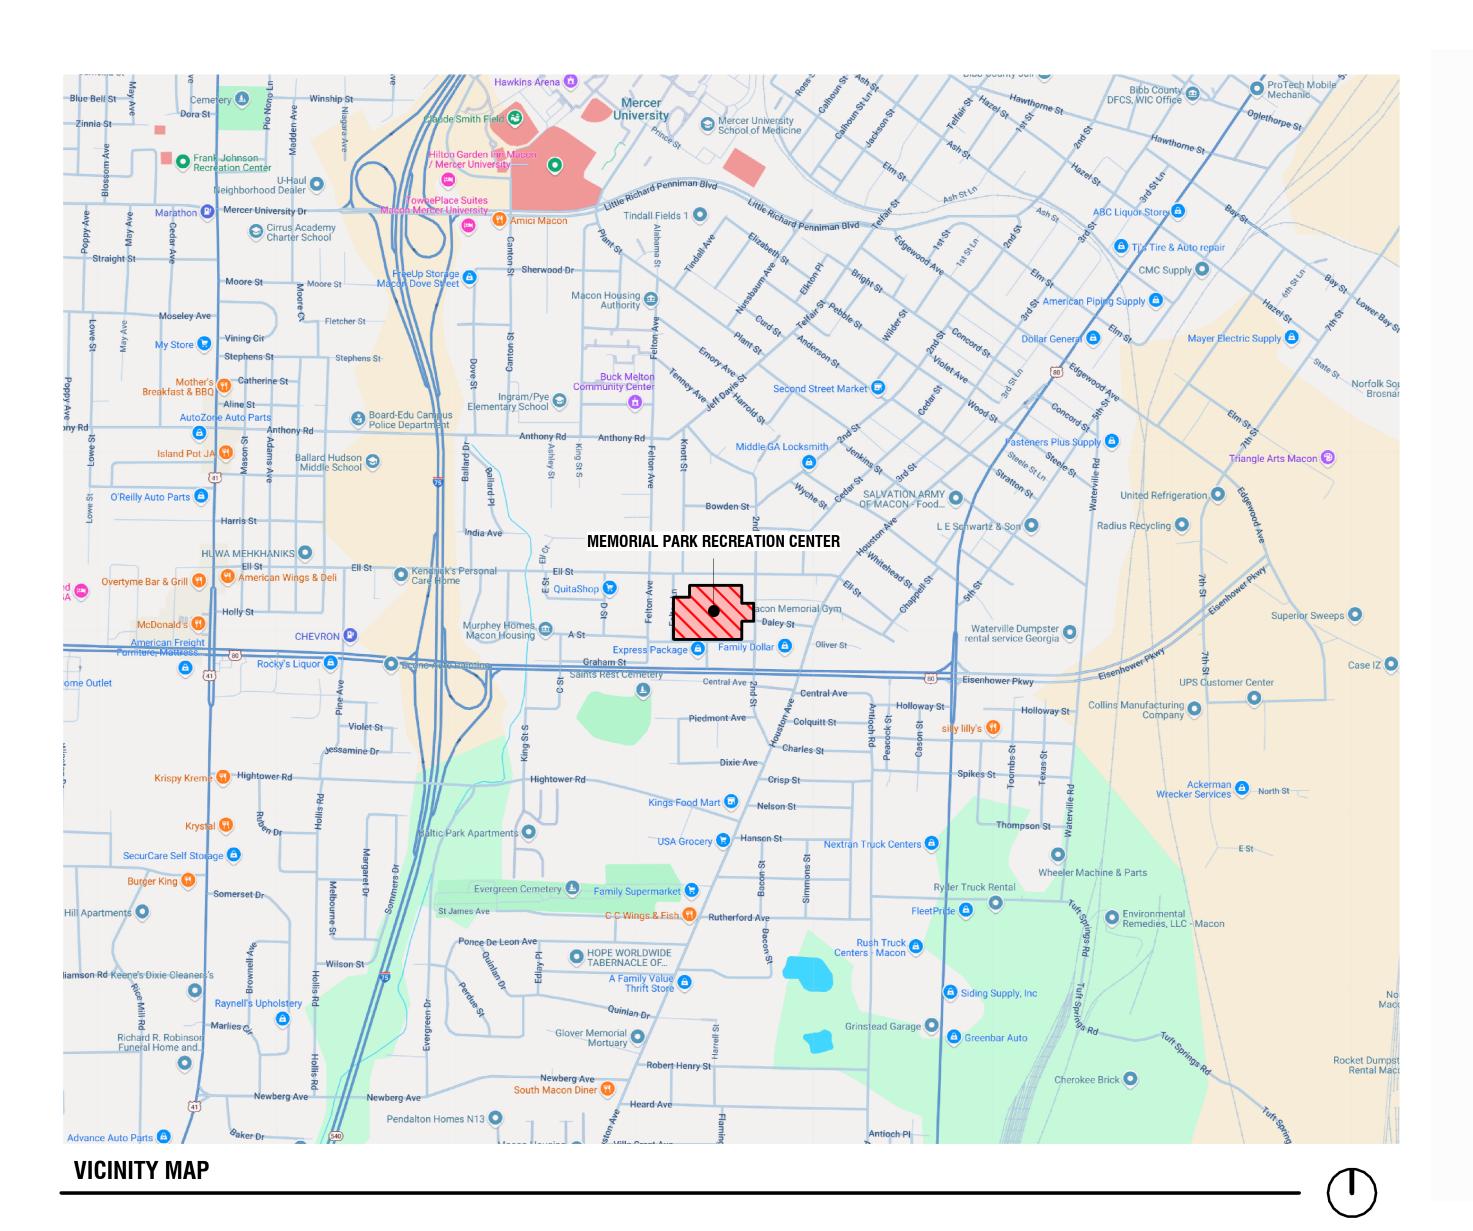



LIST OF DRAWINGS							
Sheet Number	Sheet Name						
General							
G101	COVERSHEET						
G102	GENERAL REQUIREMENTS						
Life Safety							
LS101	LIFE SAFETY PLAN						
10101							
Civil							
C101	EXISTING CONDITIONS AND DEMOLITION PLAN						
C201	SITE LAYOUT						
C301	GRADING AND DRAINAGE PLAN						
C401	ESPC PHASE 1						
Structural	CENTERAL MOTES AND DETAILS						
S101	GENERAL NOTES AND DETAILS						
S102	FOUNDATION AND FRAMING PLAN						
S103	BUILDING ELEVATIONS						
S104	TRUSS DIAGRAMS						
Architectural Sit	ework						
AS101	ARCHITECTURAL SITE PLAN - DEMO WORK						
AS102	ARCHITECTURAL SITE PLAN - NEW WORK						
Architecture							
A101	OVERALL FLOOR PLAN						
A102	RESTROOM - FLOOR PLANS						
A104	RESTROOM - ELEVATIONS						
A106	PAVILION PLAN, ELEVATIONS AND SECTIONS						
A201	BUILDING ELEVATIONS						
A501	INTERIOR ELEVATIONS						
A502	INTERIOR ELEVATIONS						
A701	FINISH PLAN, SCHEDULE, AND LEGEND						
A702	INTERIOR 3D VIEWS						
Mechanical							
M101	MECHANICAL PLAN						
141101	INTEGRATIONE LEAR						
Electrical							
E101	FLOOR PLAN - ELECTRICAL						
Plumbing							
P101	PLUMBING PLANS						

CONTACT INFORMATION

CIVIL
TRAVERSE LAND SERVICES, LLC
253 CARL VINSON PARKWAY
WARNER ROBINS, GA. 31088
478-922-7724
CONTACT: MICHAEL CLARKE

STRUCTURAL
PI-TECH, INC.
115 FOREST HILL RD, MACON, GA 31210
478.743.5600
CONTACT: MATT ELLIS

ARCHITECTURAL
WM2A ARCHITECTS
348 COTTON AVENUE SUITE 500
MACON, GA 31201
478-745-4945
CONTACT: BRANDON FAIRBANKS

MECHANICAL
TOTAL ENGINEERS
169 NEW STREET, MACON, GA 3120
478-741-4632
CONTACT: KRUNAL PATEL

PLUMBING
TOTAL ENGINEERS
169 NEW STREET, MACON, GA 31201
478-741-4632
CONTACT: KRUNAL PATEL

ELECTRICAL
ELECTRICAL DESIGN CONSULTANTS
175 NEW STREET, SUITE 1
MACON, GA 31201
478-781-1833
CONTACT: JEFF McGEE

These drawings convey certain contractual information through the use of color. Do NOT use drawings printed in black-and-white or greyscale.

© 2023, WMA Architects/Planners, Inc. d/b/a WM2A Architects.

These drawings, as instruments of service, remain the property of the Architect.
Unauthorized use or reproduction is forbidden.

Project Status:

Issued for Permit

Project No: Current Date: 2024-079 10/30/24

Name:

COVERSHEET

G101

PERMITS & STANDARDS

- I. ALL NECESSARY FEDERAL, STATE AND LOCAL PERMITS REQUIRED TO PERFORM THE WORK SHOWN AND NOTED HEREON SHALL BE OBTAINED FROM THE ISSUING AUTHORITY, PRIOR TO THE COMMENCEMENT OF ANY CONSTRUCTION ACTIVITY.
- 2. ALL CONSTRUCTION SHALL CONFORM TO ALL APPLICABLE RULES. REGULATIONS. STANDARDS & SPECIFICATIONS OF THE CITY MACON, GEORGIA, REGARDLESS OF THE ABSENCE OF "REVIEW/INSPECTION COMMENTS".
- 3. THE CONTRACTOR IS REQUIRED TO NOTIFY THE LOCAL INSPECTOR 24 HOURS PRIOR TO ANY CONSTRUCTION ACTIVITIES.
- 4. THE PROJECT SITE IS SUBJECT TO ALL RIGHT-OF-WAYS & EASEMENTS SHOWN AND/OR RECORDED, AND MAY BE SUBJECT TO ADDITIONAL RIGHT-OF-WAYS/EASEMENTS NOT SHOWN OR RECORDED HEREON.
- 5. THE CONTRACTOR SHALL PERFORM A SITE INSPECTION PRIOR TO ANY CONSTRUCTION ACTIVITY, TO IDENTIFY ANY DISCREPANCIES BETWEEN THE APPROVED CONSTRUCTION DOCUMENTS AND EXISTING SITE CONDITIONS. IF DISCREPANCIES EXIST, THE CONTRACTOR SHALL NOTIFY IN WRITING TO THE OWNER AND TRAVERSE LAND SERVICES PRIOR TO WORK COMMENCEMENT.
- 6. THE LIMITS OF CONSTRUCTION HAVE BEEN DELINEATED ON THE SITE PLAN. REFER TO SPECIFICATIONS FOR PERIMETER FENCING. THE CONTRACTOR SHALL CONTAIN ALL CONSTRUCTION ACTIVITIES WITHIN THESE LIMITS. ANY REPAIR OR RECONSTRUCTION OF DAMAGE TO ADJACENT PROPERTIES SHALL BE REPAIRED BY THE CONTRACTOR ON AN IMMEDIATE BASIS. ALL COSTS INCURRED FOR SAID REPAIRS SHALL BE THE RESPONSIBILITY OF THE CONTRACTOR AND NO EXTRA COMPENSATION SHALL BE PROVIDED.
- 7. UNLESS OTHERWISE NOTED, THE CONTRACTOR SHALL USE THE GEOMETRY PROVIDED ON THE CONSTRUCTION DOCUMENTS. ALL DIMENSIONS SHOWN ARE PERPENDICULAR/RADIAL AND ARE MEASURED FACE TO FACE OF CURB \$ BUILDINGS OR FROM THE EDGE OF PAVEMENT IN THE ABSENCE OF CURBING.
- 8. ALL GRADED AREAS SHALL PROVIDE POSITIVE DRAINAGE IN THE DIRECTION INDICATED ON THE CONSTRUCTION DOCUMENTS SO AS TO PROVIDE A SMOOTH TRANSITION BETWEEN SURFACES WITH NO SHARP BREAKS IN GRADE AND NO STEEP OR REVERSE CROSS SLOPES. MINOR FIELD ADJUSTMENTS TO PROPOSED GRADES MAY BE NECESSARY TO CONSTRUCT THE DESIGN INTENT. IT IS THE CONTRACTOR'S RESPONSIBILITY TO ACCOMPLISH THE ABOVE.
- 9. CONTRACTOR SHALL VERIFY INVERTS & SPOT ELEVATIONS OF ALL TIE-INS TO EXISTING INFRASTRUCTURE & PAVEMENT PRIOR TO INSTALLATION.
- 10. ALL PAVEMENT TO BE REMOVED SHALL BE SAW CUT.
- II. IT SHALL BE THE RESPONSIBILITY OF THE CONTRACTOR TO INSURE PRIOR TO ORDERING PROJECT MATERIALS, THE MOST CURRENT SET OF "APPROVED" CONSTRUCTION DOCUMENTS FROM TRAVERSE LAND SERVICES INCLUDING BUT NOT LIMITED TO, PERMITTED SET(S) FROM ALL APPLICABLE AGENCIES AS APPROPRIATE. TRAVERSE LAND SERVICES SHALL ACCEPT NO RESPONSIBILITY FOR IMPROPER ORDERING OF MATERIALS.
- 12. DO NOT SCALE FROM THESE DRAWINGS." DIFFERENTIAL STRETCHING" OCCURS DURING THE REPRODUCTION PROCESS.
- 13. AN AS-BUILT SITE SURVEY AND REVISED HYDROLOGY/HYDRAULIC ANALYSIS SHALL BE SUBMITTED TO THE LOCAL CITY OR COUNTY GOVERNMENTAL AGENCY PRIOR TO FINAL APPROVAL AND ISSUANCE OF "CERTIFICATE OF OCCUPANCY" FOR THIS PROJECT.

UTILITIES


- I. ALL WATER & SEWER CONSTRUCTION SHALL BE IN ACCORDANCE WITH THE MACON WATER AUTHORITY UTILITY DEPARTMENT WATER & SEWER STANDARDS, LATEST ADDITION.
- 2. ALL UTILITY WORK MEETING THE DEFINITION OF "UTILITY CONTRACTING" AS DESCRIBED IN THE OFFICIAL CODE OF THE STATE OF GEORGIA, SECTION 43-14-2 SHALL ADHERE TO THE PRESCRIBED SECTIONS REGARDING "UTILITY CONTRACTOR" LICENSING REQUIREMENTS.
- 3. .ALL UTILITIES, STORM DRAIN & SERVICE LINES SHALL BE MARKED WITH LOCATOR WIRE.
- 4. CAUTION! UNDERGROUND UTILITY SERVICE ALERT I THE CONTRACTOR SHALL CALL THE TOLL FREE NUMBER-1.800.282.7411. A MINIMUM OF 48 HOURS PRIOR TO THE START OF ANY EXCAVATION AS SHOWN AND NOTED ON THE APPROVED PLANS.
- 5. INFRASTRUCTURE AND/OR UTILITIES SHOWN ON THESE PLANS ARE FROM GROUND LOCATION OF IDENTIFIABLE STRUCTURES AND "SURFACE DELINIATIONS" OF UNDERGROUND INFRASTRUCTURE (UPC) AVAILABLE AT THE TIME OF THE DESIGN SURVEY. ADDITIONAL SURFACE \$ SUB-SURFACE INFRASTRUCTURE MAY EXIST. TRAVERSE LAND SERVICES ACCEPTS NO RESPONSIBILITY FOR THE COMPLETENESS OF THIS INFORMATION.
- 6. THE CONTRACTOR IS RESPONSIBLE FOR DETERMINING THE EXACT LOCATION OF ANY SAID UTILITIES PRIOR TO WORK COMMENCEMENT AND TO SAFEGUARD EXISTING UTILITIES FROM DAMAGE DURING CONSTRUCTION. THE CONTRACTOR IS SOLELY RESPONSIBLE FOR ALL DAMAGES TO EXISTING UTILITIES. THE CONTRACTOR SHALL NOTIFY TRAVERSE LAND SERVICES IMMEDIATELY IF ANY EXISTING UTILITY LOCATIONS WILL EFFECT OR IMPEDE THE PROGRESSION OR COMPLETION OF THE DESIGN INTENT AS SHOWN HEREON.
- 7. THE CONTRACTOR SHALL COORDINATE WITH THE APPROPRIATE UTILITY ENTITY WITH ANY REQUIRED RELOCATION OF EXISTING UTILITIES, PRIOR TO THE START OF ANY CONSTRUCTION.
- 8. THE CONTRACTOR SHALL REMOVE SAID UTILITIES ONLY, AFTER APPROVAL FROM ALL INTERESTED PARTIES. THE CONTRACTOR SHALL COORDINATE ABANDONMENT AND/OR RELOCATION WITH THE APPROPRIATE UTILITY COMPANY OR ENTITY. ANY DISPOSAL OF SAID FACILITIES SHALL BE PERFORMED IN ACCORDANCE WITH LOCAL UTILITY AND OR GOVERNMENTAL REGULATIONS. ANY COSTS INCURRED IN THE REMOVAL/ABANDONMENT OF SAID INFRASTRUCTURE SHALL BE THE RESPONSIBILITY OF THE OWNER/CONTRACTOR.

CLEARING & GRADING


- I. THE CONTRACTOR SHALL EXORCISE EXTREME CAUTION IN PROTECTING EXISTING TRESS/VEGETATION AND COORDINATE ALL TREE REMOVAL WITH THE OWNER PRIOR TO THE START OF ANY CONSTRUCTION.
- 2. THE CONTRACTOR SHALL REMOVE ALL WASTE MATERIAL EXCAVATED FROM THE SITE AND DISPOSED OF PROPERLY OFF-SITE.
- 3. STRUCTURAL FILL MATERIAL REQUIRED TO BRING THE SITE TO GRADE SHALL BE LIMITED TO SOILS CLASSIFIED IN ACCORDANCE WITH ASTM D2487. ON-SITE SOILS FROM CUT AREAS MAY BE SUITABLE FOR FILL MATERIAL
- 4. THE CONTRACTOR SHALL STOCKPILE AND LATER SPREAD A MINIMUM OF 6 INCHES OF TOPSOIL IN AREAS TO BE LANDSCAPED, SODDED OR SEEDED.
- 5. AT THE END OF EACH DAY, THE CONTRACTOR SHALL HAVE THE SITE GRADED IN SUCH A WAY SO AS NOT TO CAUSE ADVERSE IMPACT FROM RUN-OFF OR SILTATION TO ANY ADJACENT PROPERTIES. SILT BARRIERS SHALL BE MAINTAINED AND REPAIRED IF REQUIRED AT THE END OF EACH WORKING DAY .
- 6. GROUND SURFACE PREPARATION:
 - 6.1. REMOVE VEGETATION INCLUDING GRASS, ROOTS, AND SURFICIAL ORGANICS, DEBRIS, UNSATISFACTORY SOILS, OBSTRUCTIONS, AND DELETERIOUS MATERIALS FROM THE GROUND SURFACE PRIOR TO THE PLACEMENT OF FILL MATERIAL. PLOW STRIP, BREAKUP SLOPED SURFACES STEEPER THAN 2:1 SO THAT FILL MATERIAL WILL BOND WITH THE EXISTING SOILS. WHEN EXISTING GROUND SURFACE HAS A DENSITY LESS THAT THAT SPECIFIED UNDER COMPACTION FOR PARTICULAR AREA CLASSIFICATION, BREAKUP GROUND SURFACE, PULVERIZE, MOISTURE CONDITION TO OPTIMUM MOISTURE CONTENT, AND COMPACT TO REQUIRED DEPTH AND PERCENTAGE OF MAXIMUM DENSITY
- 6.2. PLACE BACKFILL AND FILL MATERIAL IN LAYERS NOT MORE THAN 6 INCHES IN LOOSE FILL LIFTS COMPACTED BY HEAVY EQUIPMENT AND NOT MORE THAN 3 INCHES IN LOOSE FILL LIFTS COMPACTED BY HAND-OPERATED TAMPERS.
- 6.3. BEFORE COMPACTION, MOISTEN AND AERATE EACH LAYER AS NECESSARY TO PROVIDE OPTIMUM MOISTURE CONTENT. COMPACT EACH LAYER TO REQUIRED PERCENTAGE OF MAXIMUM DRY DENSITY OR RELATIVE DRY DENSITY FOR EACH AREA CLASSIFICATION. DO NOT PLACE BACKFILL OR FILL MATERIAL ON SURFACES THAT ARE MUDDY, FROZEN, OR CONTAINS FROST OR ICE.
- 6.4. UNLESS OTHERWISE INDICATED OR DIRECTED BY GEOTECHNICAL CONSULTANT, COMPACT ALL BUILDING PADS & PAVEMENT SUBGRADE MATERIAL TO 98% STANDARD PROCTOR MAXIMUM DRY DENSITY (ASTMD698 CURRENT ADDITION). OTHER GRADED AREAS SHALL BE COMPACTED TO 95% STANDARD PROCTOR DRY DENSITY (+/- 2%) UNLESS OTHERWISE
- 6.5. ALL GRADED AREAS SHALL BE PROOFROLLED WITH A 20 TON DUMP TRUCK, UNDERCUT ALL AREAS THAT PUMP AND REPLACE WITH SUITABLE FILL MATERIAL AS SPECIFIED.
- 7. MOISTURE CONTROL:
- 7. I. WHERE SUBSURFACE OR LAYER OF SOIL MATERIAL MUST BE MOISTURE CONDITIONED BEFORE COMPACTION, UNIFORMLY APPLY WATER TO SURFACE OF SUBGRADE OR SOIL LAYER. APPLY WATER IN MINIMUM QUANTITIES AS NECESSARY TO PREVENT FREE WATER FROM APPEARING ON THE SURFACE DURING OR SUBSEQUENT TO COMPACTION **OPERATIONS**
- 7.2. REMOVE AND REPLACE, OR SCARIFY AND AIR DRY, SOIL MATERIAL THAT IS TOO WET TO ALLOW FOR REQUIRED SPECIFIED DENSITY.
- 7.3. SPREAD SOIL MATERIAL THAT HAS BEEN REMOVED DUE TO EXCESSIVE MOISTURE CONTENT. ASSIST THE DRYING PROCESS BY DISKING. HARROWING. OR PULVERIZING UNTIL MOISTURE CONTENT IS REDUCED TO A SATISFACTORY VALUE.
- 7.4. THE CONTRACTOR SHALL NOTIFY TRAVERSE LAND SERVICES \$ OWNER IMMEDIATELY UPON THE DISCOVERY OF ANY GROUNDWATER. SUB-SURFACE SEEPAGE. OR SPRINGS DURING THE COURSE OF CONSTRUCTION. IT SHALL BE THE RESPONSIBILITY OF THE OWNER TO CONSULT WITH A REGISTERED GEOTECHNICAL ENGINEER FOR SITE INSPECTION. AND TO MAKE RECOMMENDATIONS REGARDING THE EVIDENCE AND REMEDIATION OF SUBSURFACE
- 8. QUALITY CONTROL TESTING DURING CONSTRUCTION:
- 8. I. ALLOW GEOTECHNICAL TESTING SERVICE TO INSPECT AND APPROVE EACH SUBGRADE. BACKFILL OR FILL LAYER BEFORE FURTHER FILL OR CONSTRUCTION WORK IS CONTINUED. TESTING SHALL BE PERFORMED EVERY 10,000 SF OF AREA PER ONE FOOT LIFT OR AS DIRECTED BY A REGISTERED GEOTECHNICAL ENGINEER.
- 8.2. GEOTECHNICAL SPECIFICATIONS DESCRIBED HEREIN ARE GUIDELINES ONLY AND SHOULD BE VERIFIED BY A REGISTERED GEOTECHNICAL ENGINEER PRIOR TO THE COMMENCEMENT OF CONSTRUCTION. RECOMMENDATIONS FROM A REGISTERED GEOTECHNICAL ENGINEER SHALL SUPERSEDE THE ABOVE RECOMMENDATIONS.

MATERIALS

- I. IT SHALL BE THE RESPONSIBILITY OF THE CONTRACTOR TO INSURE PRIOR TO ORDERING PROJECT MATERIALS, THE MOST CURRENT SET OF "APPROVED" CONSTRUCTION DOCUMENTS INCLUDING BUT NOT LIMITED TO, PERMITTED SET(S) FROM ALL APPLICABLE AGENCIES AS APPROPRIATE. TRAVERSE LAND SERVICES SHALL ACCEPT NO RESPONSIBILITY FOR IMPROPER ORDERING OF MATERIALS.
- 2. WATER, SEWER & STORM PIPE MATERIALS SHALL CONFORM TO THE FOLLOWING STANDARDS. 2.1. WATER MAINS DUCTILE IRON PIPE CLASS 350 (AWWA C 151)
 - PVC C-900 SDR-21 WITH UTILITY AUTHORITY APPROVAL
- 2.2. SERVICE LINES PVC SCHEDULE 40
- HDPE SDR 9 (ASTM D3035)
- PURPLE PIPE (ASTM 2737) 2.3. IRRIGATION:
- 2.4. SANITARY SEWER: DUCTILE IRON PIPE CLASS 350 (AWWA C 151) PVC SDR 35 (ASTM D-3034)
- 2.5. STORM SYSTEM: RCP CLASS III (ASTM C76)
 - CORRUGATED HDPE INTEGRALLY FORMED SMOOTH INTERIOR (ASHTO M-294 TYPE 'S')

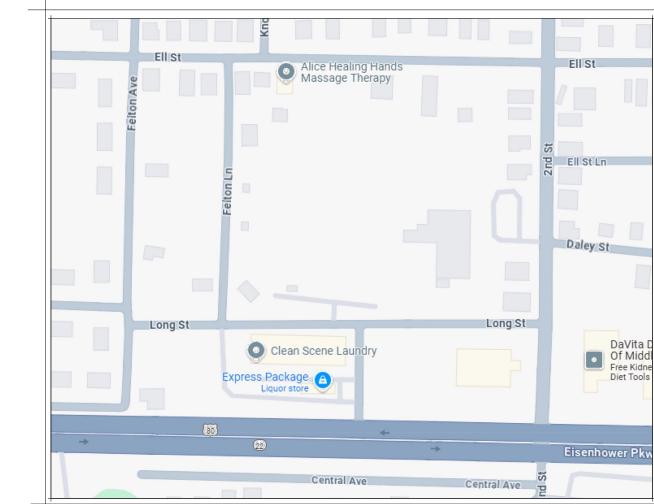




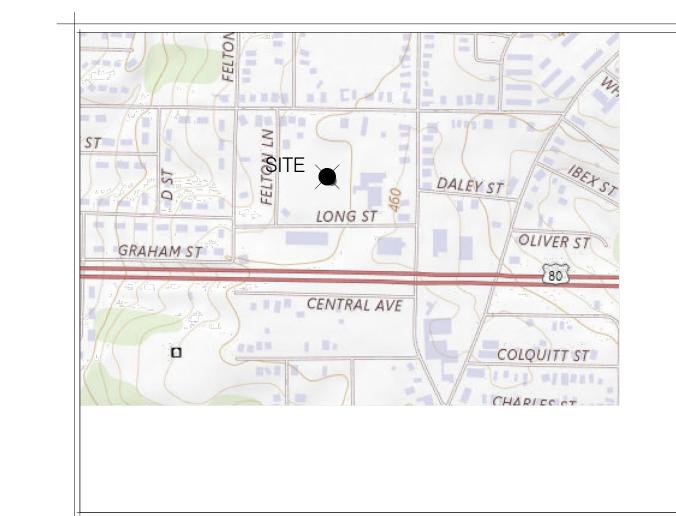


USGS QUADRANGLE




NFIP MAP FIRMETTE #13225C0130C

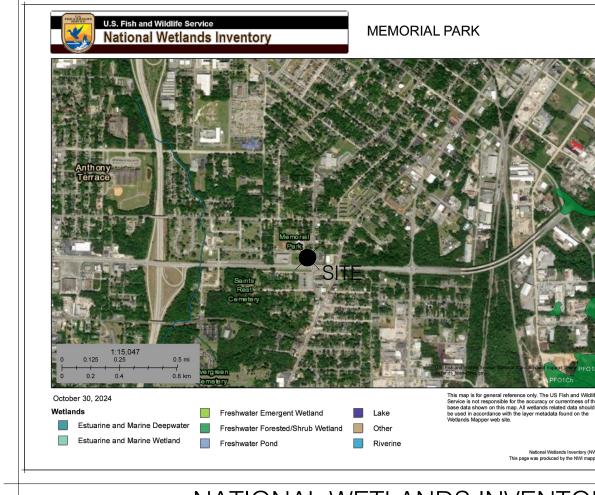

NATIONAL WETLANDS INVENTORY

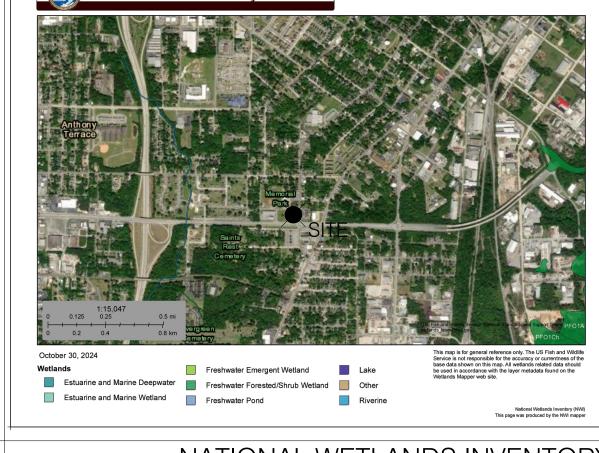

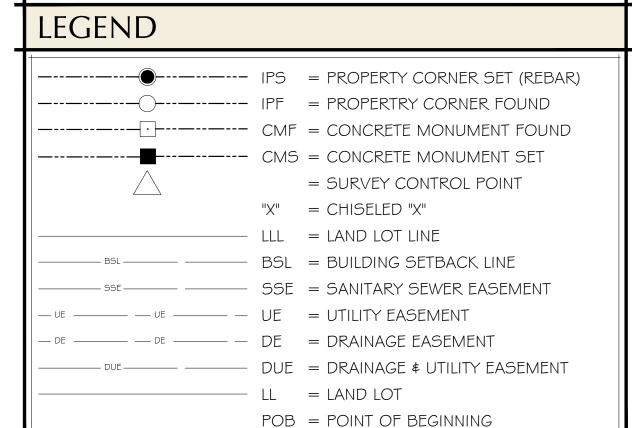

CONTACT INFORMATION OWNER/PRIMARY PERMITEE: MACON-BIBB COUNTY PO BOX 247 MACON, GEORGIA 3 I 202 24-HR CONTACT: BRANDON FAIRBANKS PHONE: 478-745-4945 EMAIL: BRANDONFAIRBANKS@WM2A.COM DESIGN PROFESSIONAL: CASEY GRAHAM

WARNER ROBINS, GEORGIA 31088 PHONE: 478-922-7724 EMAIL: CASEY.GRAHAM@TRAVERSE-LS.COM

GENERAL SITE INFORMATION

LEGAL DESCRIPTION: N/A

N/A MACON-BIBB GEORGIA

2 PHYSICAL ADDRESS: 2465 SECOND ST

ZONING-USE: EXISTING: R-2

SETBACK LINES:

PROJECT AREA:

PROPOSED: R-2

FRONT= N/A

SIDE= N/A REAR = N/A

SITE= 6.3 ACRES

DISTURBED= 0.55 ACRES 6 THIS PROPERTY IS NOT IN A SPECIAL FLOOD HAZARD DISTRICT PER NFIP FIRM PANEL No. 13021C0134G EFECTIVE DATE 06.07.2017.

"STATE WATERS" DO NOT LIE ON OR WITHIN 200' OF THE PROJECT SITE.

ARCHITECTS WM2A.COM SUITE 500, PO BOX 110







MACON-BIBB COUNTY PARKS AND RECREATION

MEMORIAL PARK RECREATION CENTER

2465 2nd St, Macon, GA 31206

STORY CLARKE & ASSOCIATES 253 CARL VINSON PARKWAY


information through the use of color. Do NOT use drawings printed in black-and-white or greyscale © 2023, WMA Architects/Planners, Inc. d/b/a WM2A Architects . These drawings, as instruments of service, remain the property of the Architect. Unauthorized use or reproduction is forbidden


Project Status: ISSUED FOR

PERMIT Revision No (if any): Revision Date: Current Date:

2024-079 10/30/24

C001

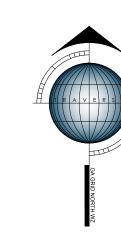

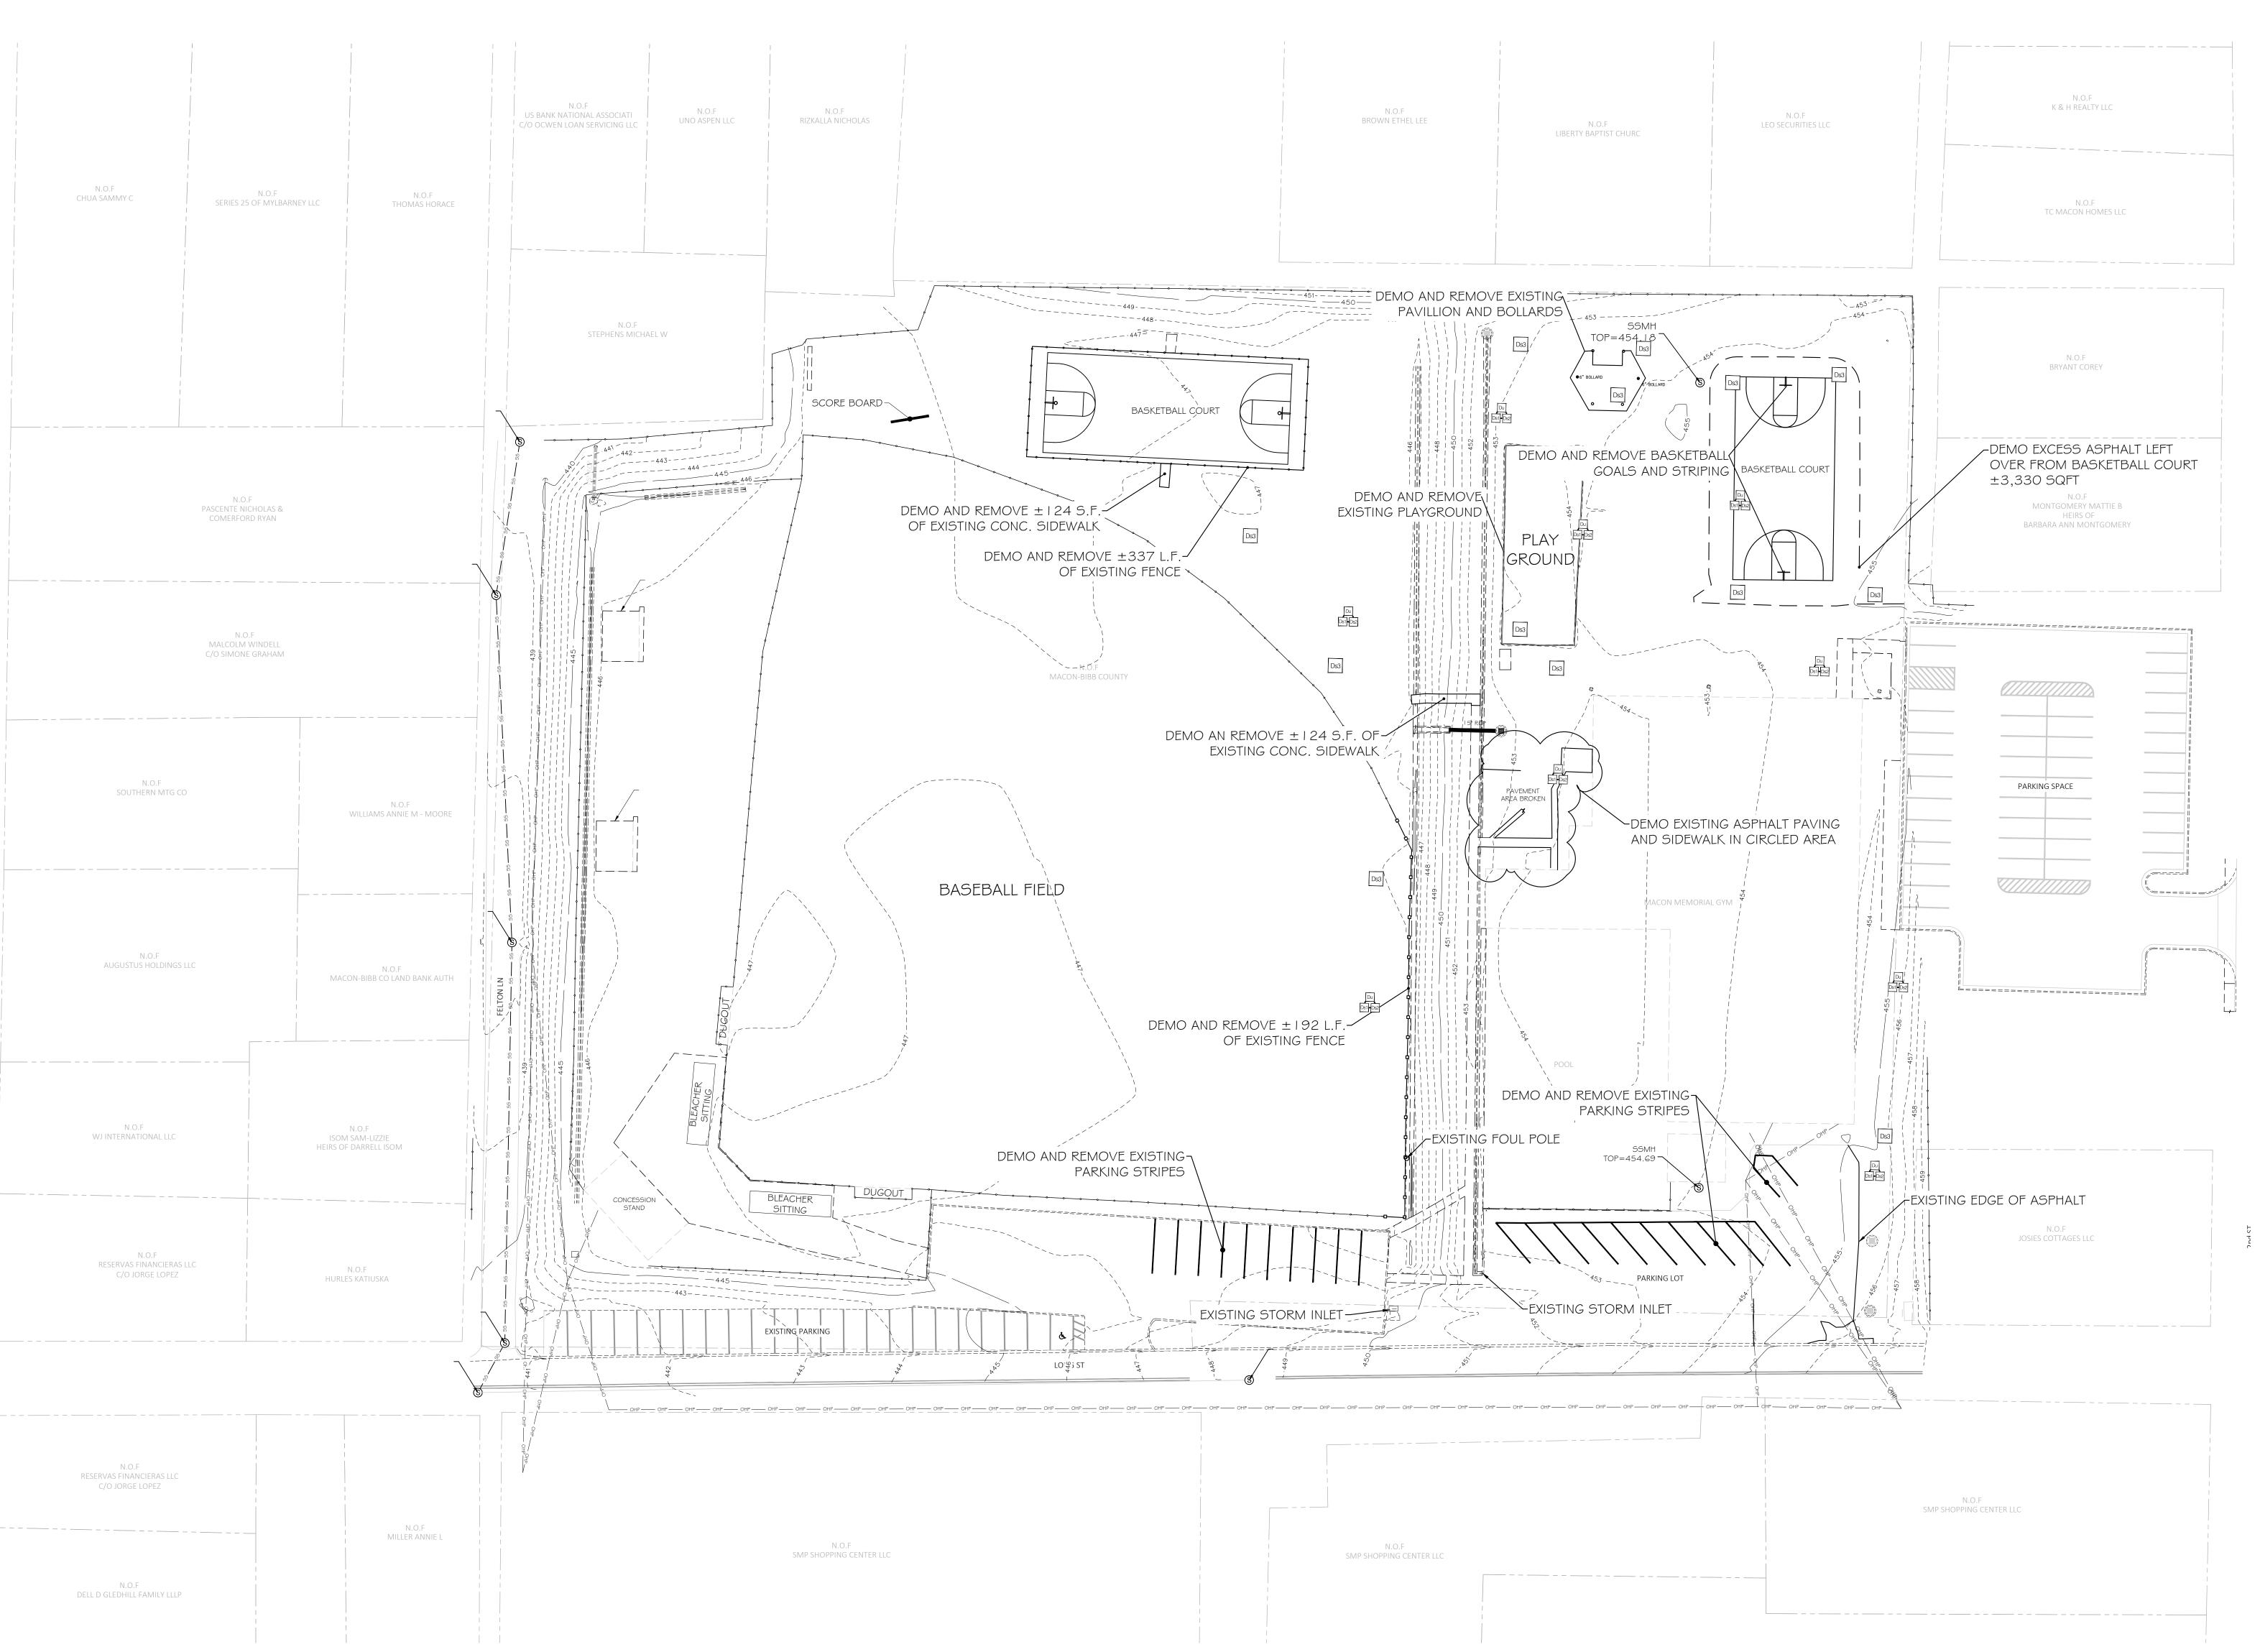









MEMORIAL PARK RECREATION CENTER

2465 2nd St, Macon, GA 31206

© 2023, WMA Architects/Planners, Inc. d/b/a WM2A Architects .

These drawings, as instruments of service, remain the property of the Architect.
Unauthorized use or reproduction is forbidden.

Project Status: ISSUED FOR PERMIT

Revision No (if any): Revision Date:

Project No: Current Date:


These drawings convey certain contractual information through the use of color. Do NOT use drawings printed in black-and-white or greyscale.


2024-079 10/30/24


Drawing Name:

EXISTING CONDITIONS
& DEMOLITION PLAN

C101

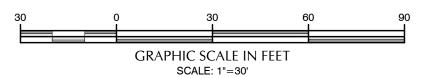

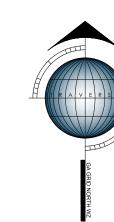

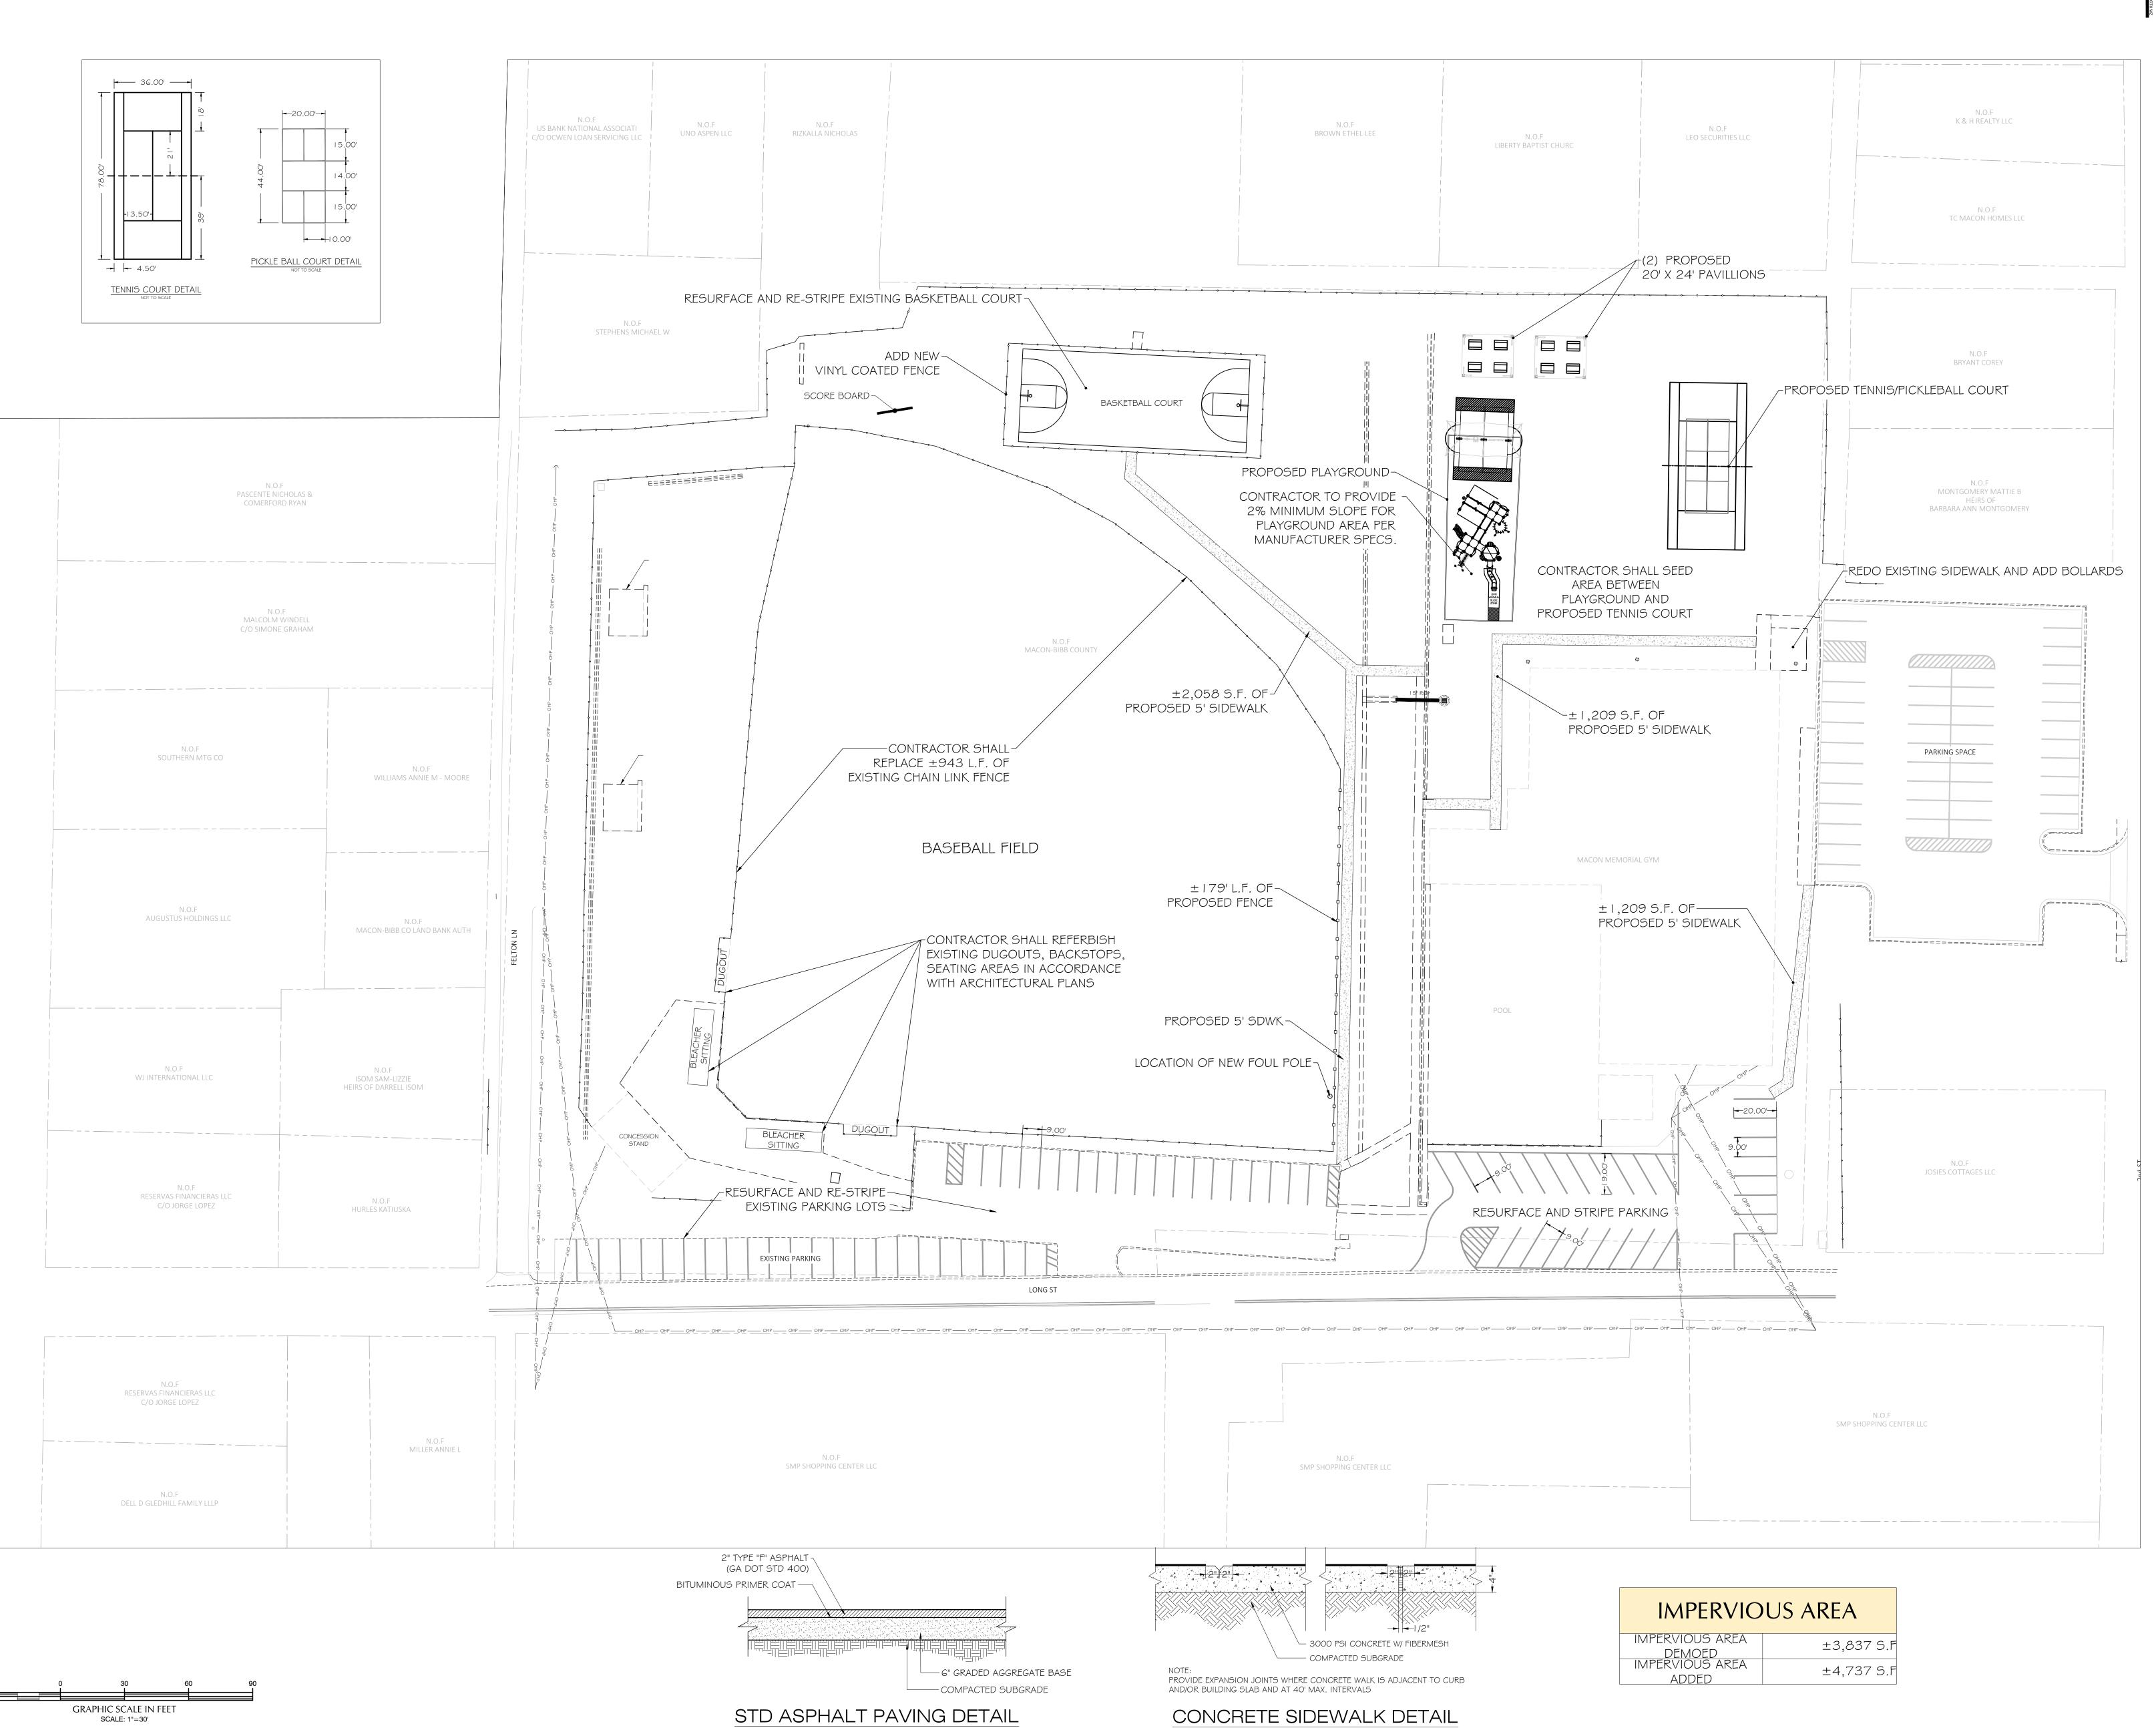









MEMORIAL PARK RECREATION CENTER RENOVATION

2465 2nd St, Macon, GA 31206

These drawings convey certain contractual information through the use of color. Do NOT use drawings printed in black-and-white or greyscale.

© 2023, WMA Architects/Planners, Inc. d/b/a WM2A Architects .
These drawings, as instruments of service, remain the property of the Architect.
Unauthorized use or reproduction is forbidden.

Project Status: ISSUED FOR

PERMIT

Revision No (if any): Revision Date:


Project No: Current Date:


2024-079 10/30/24

Drawing Name:

SITE LAYOUT

C201

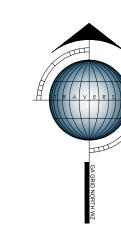

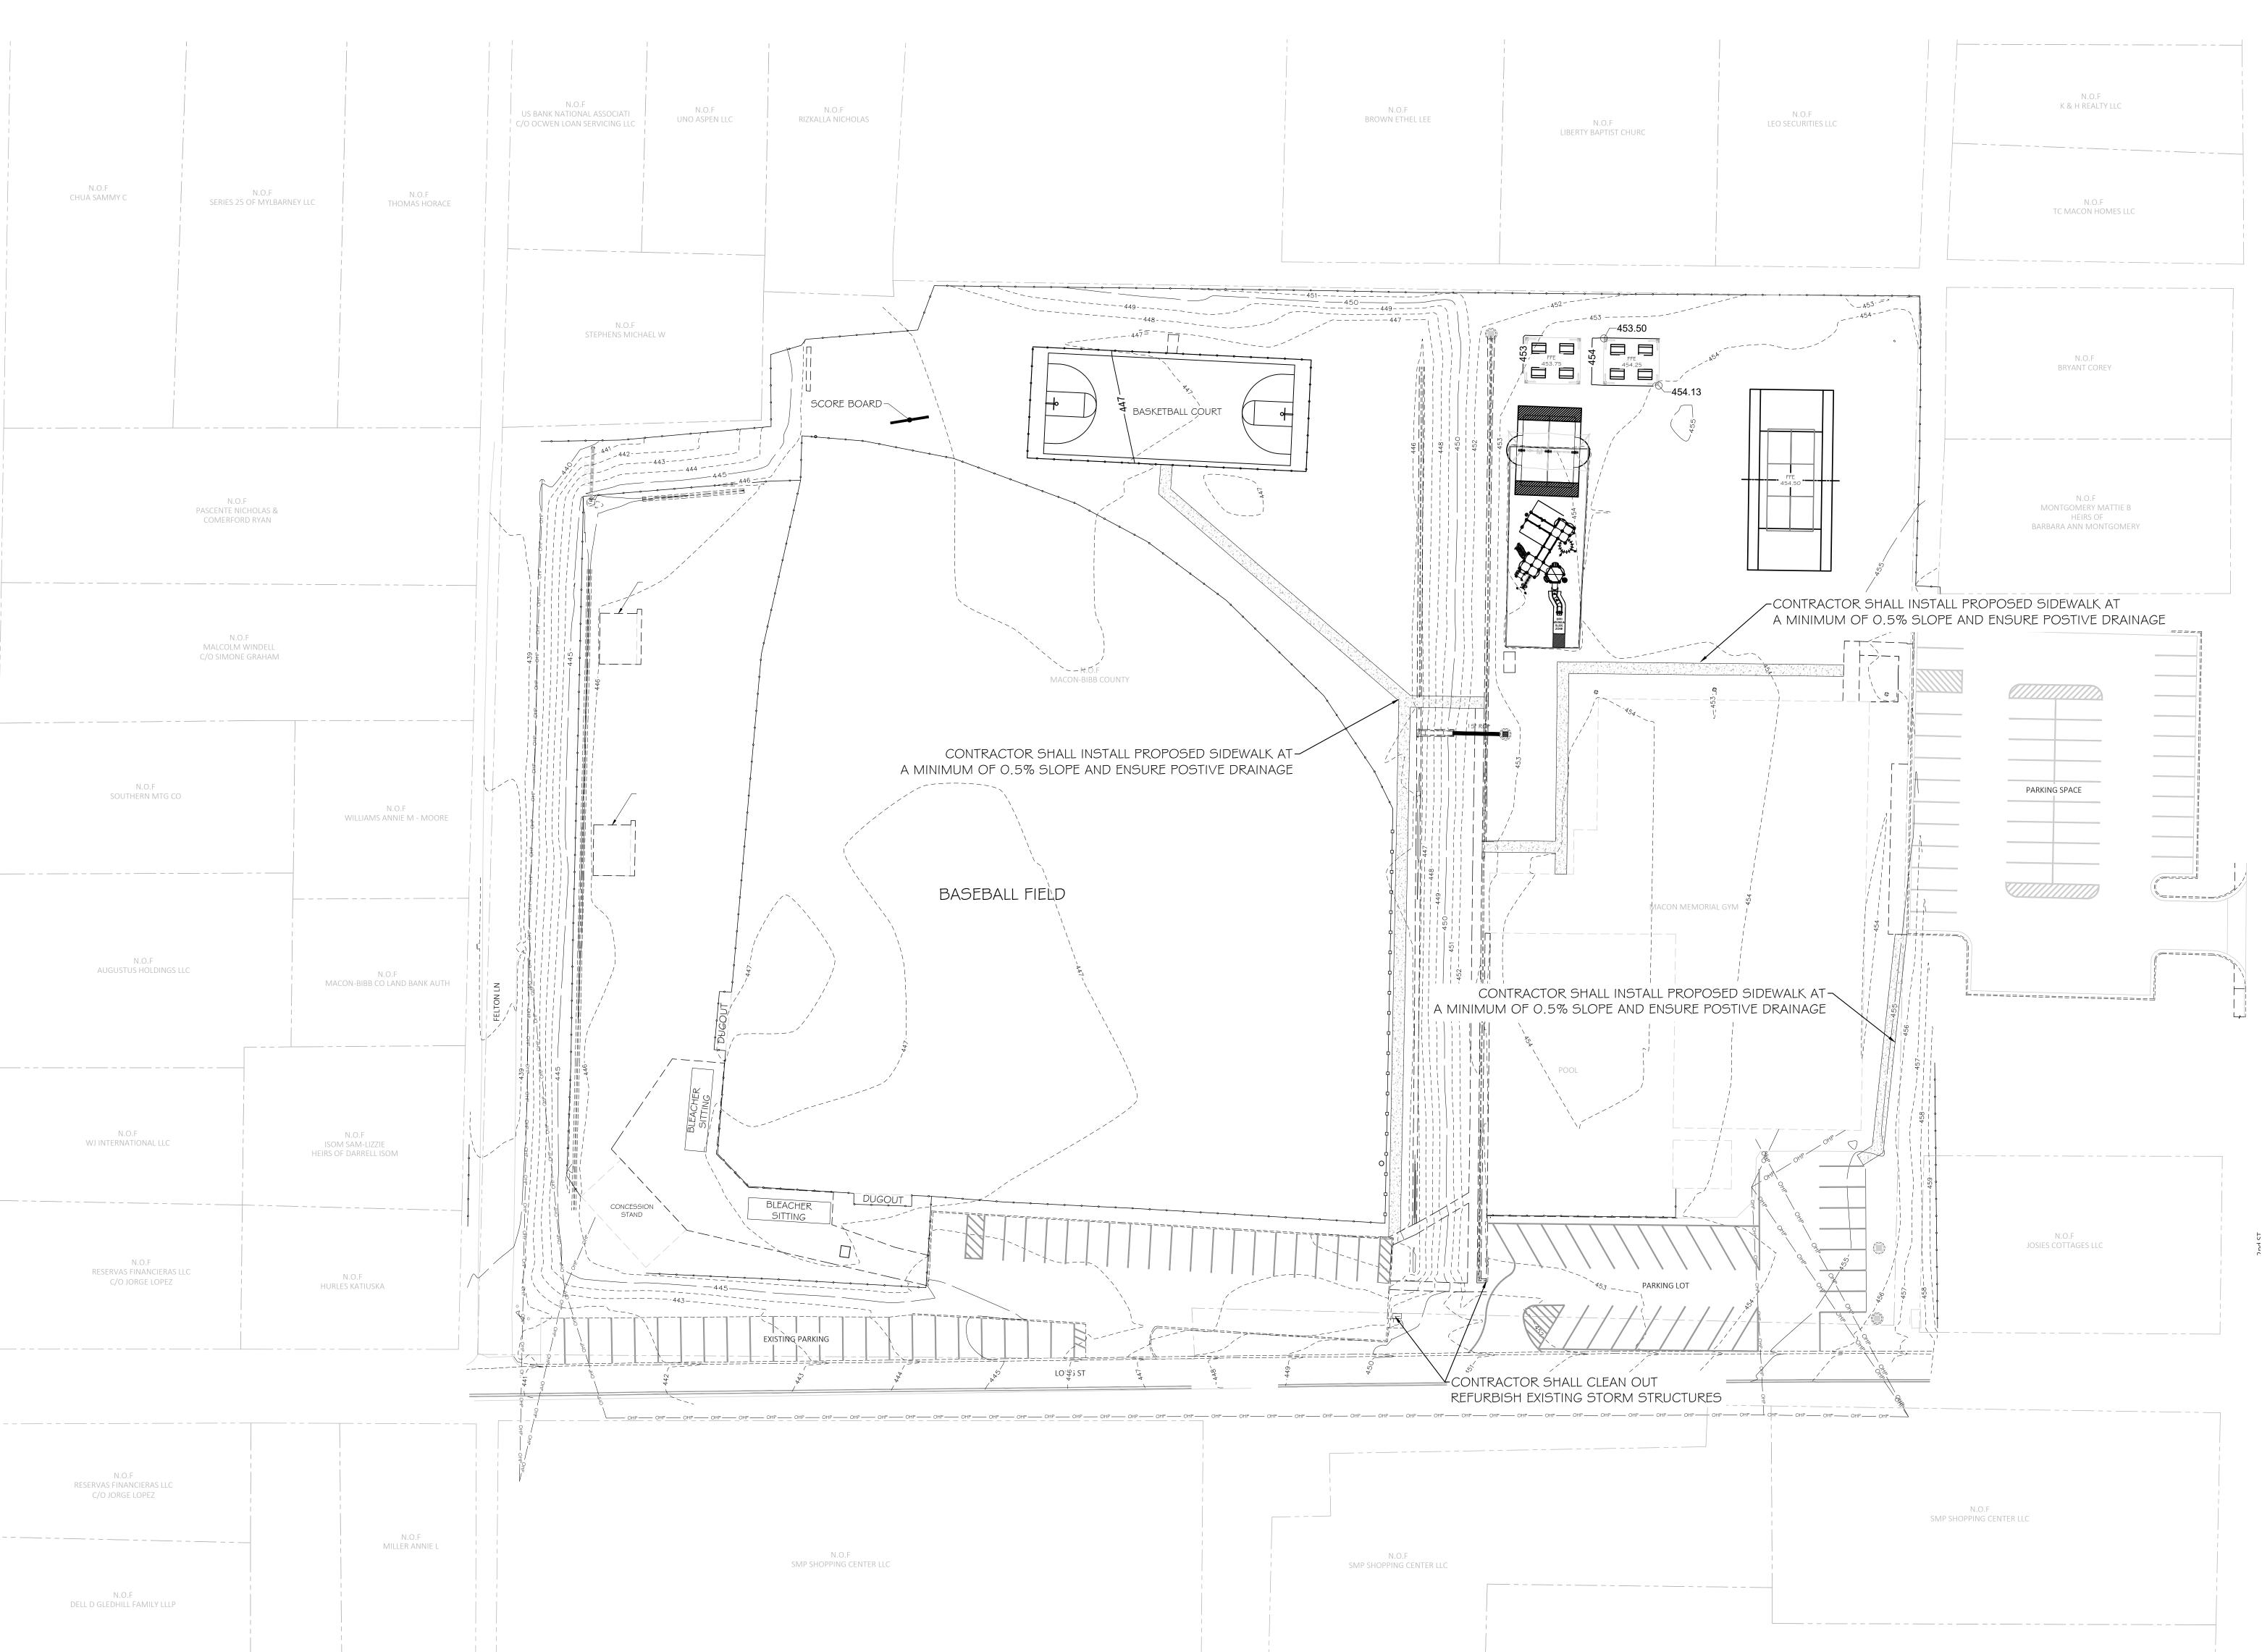









MEMORIAL PARK RECREATION CENTER RENOVATION

2465 2nd St, Macon, GA 31206

© 2023, WMA Architects/Planners, Inc. d/b/a WM2A Architects .

These drawings, as instruments of service, remain the property of the Architect.
Unauthorized use or reproduction is forbidden.

Project Status: ISSUED FOR PERMIT

Revision No (if any): Revision Date:


Project No: Current Date:


These drawings convey certain contractual information through the use of color. Do NOT use drawings printed in black-and-white or greyscale.


2024-079 10/30/24

Drawing Name:


GRADING AN DRAINAGE PLAN

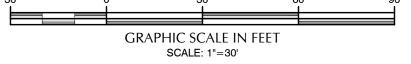

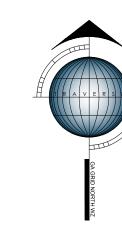

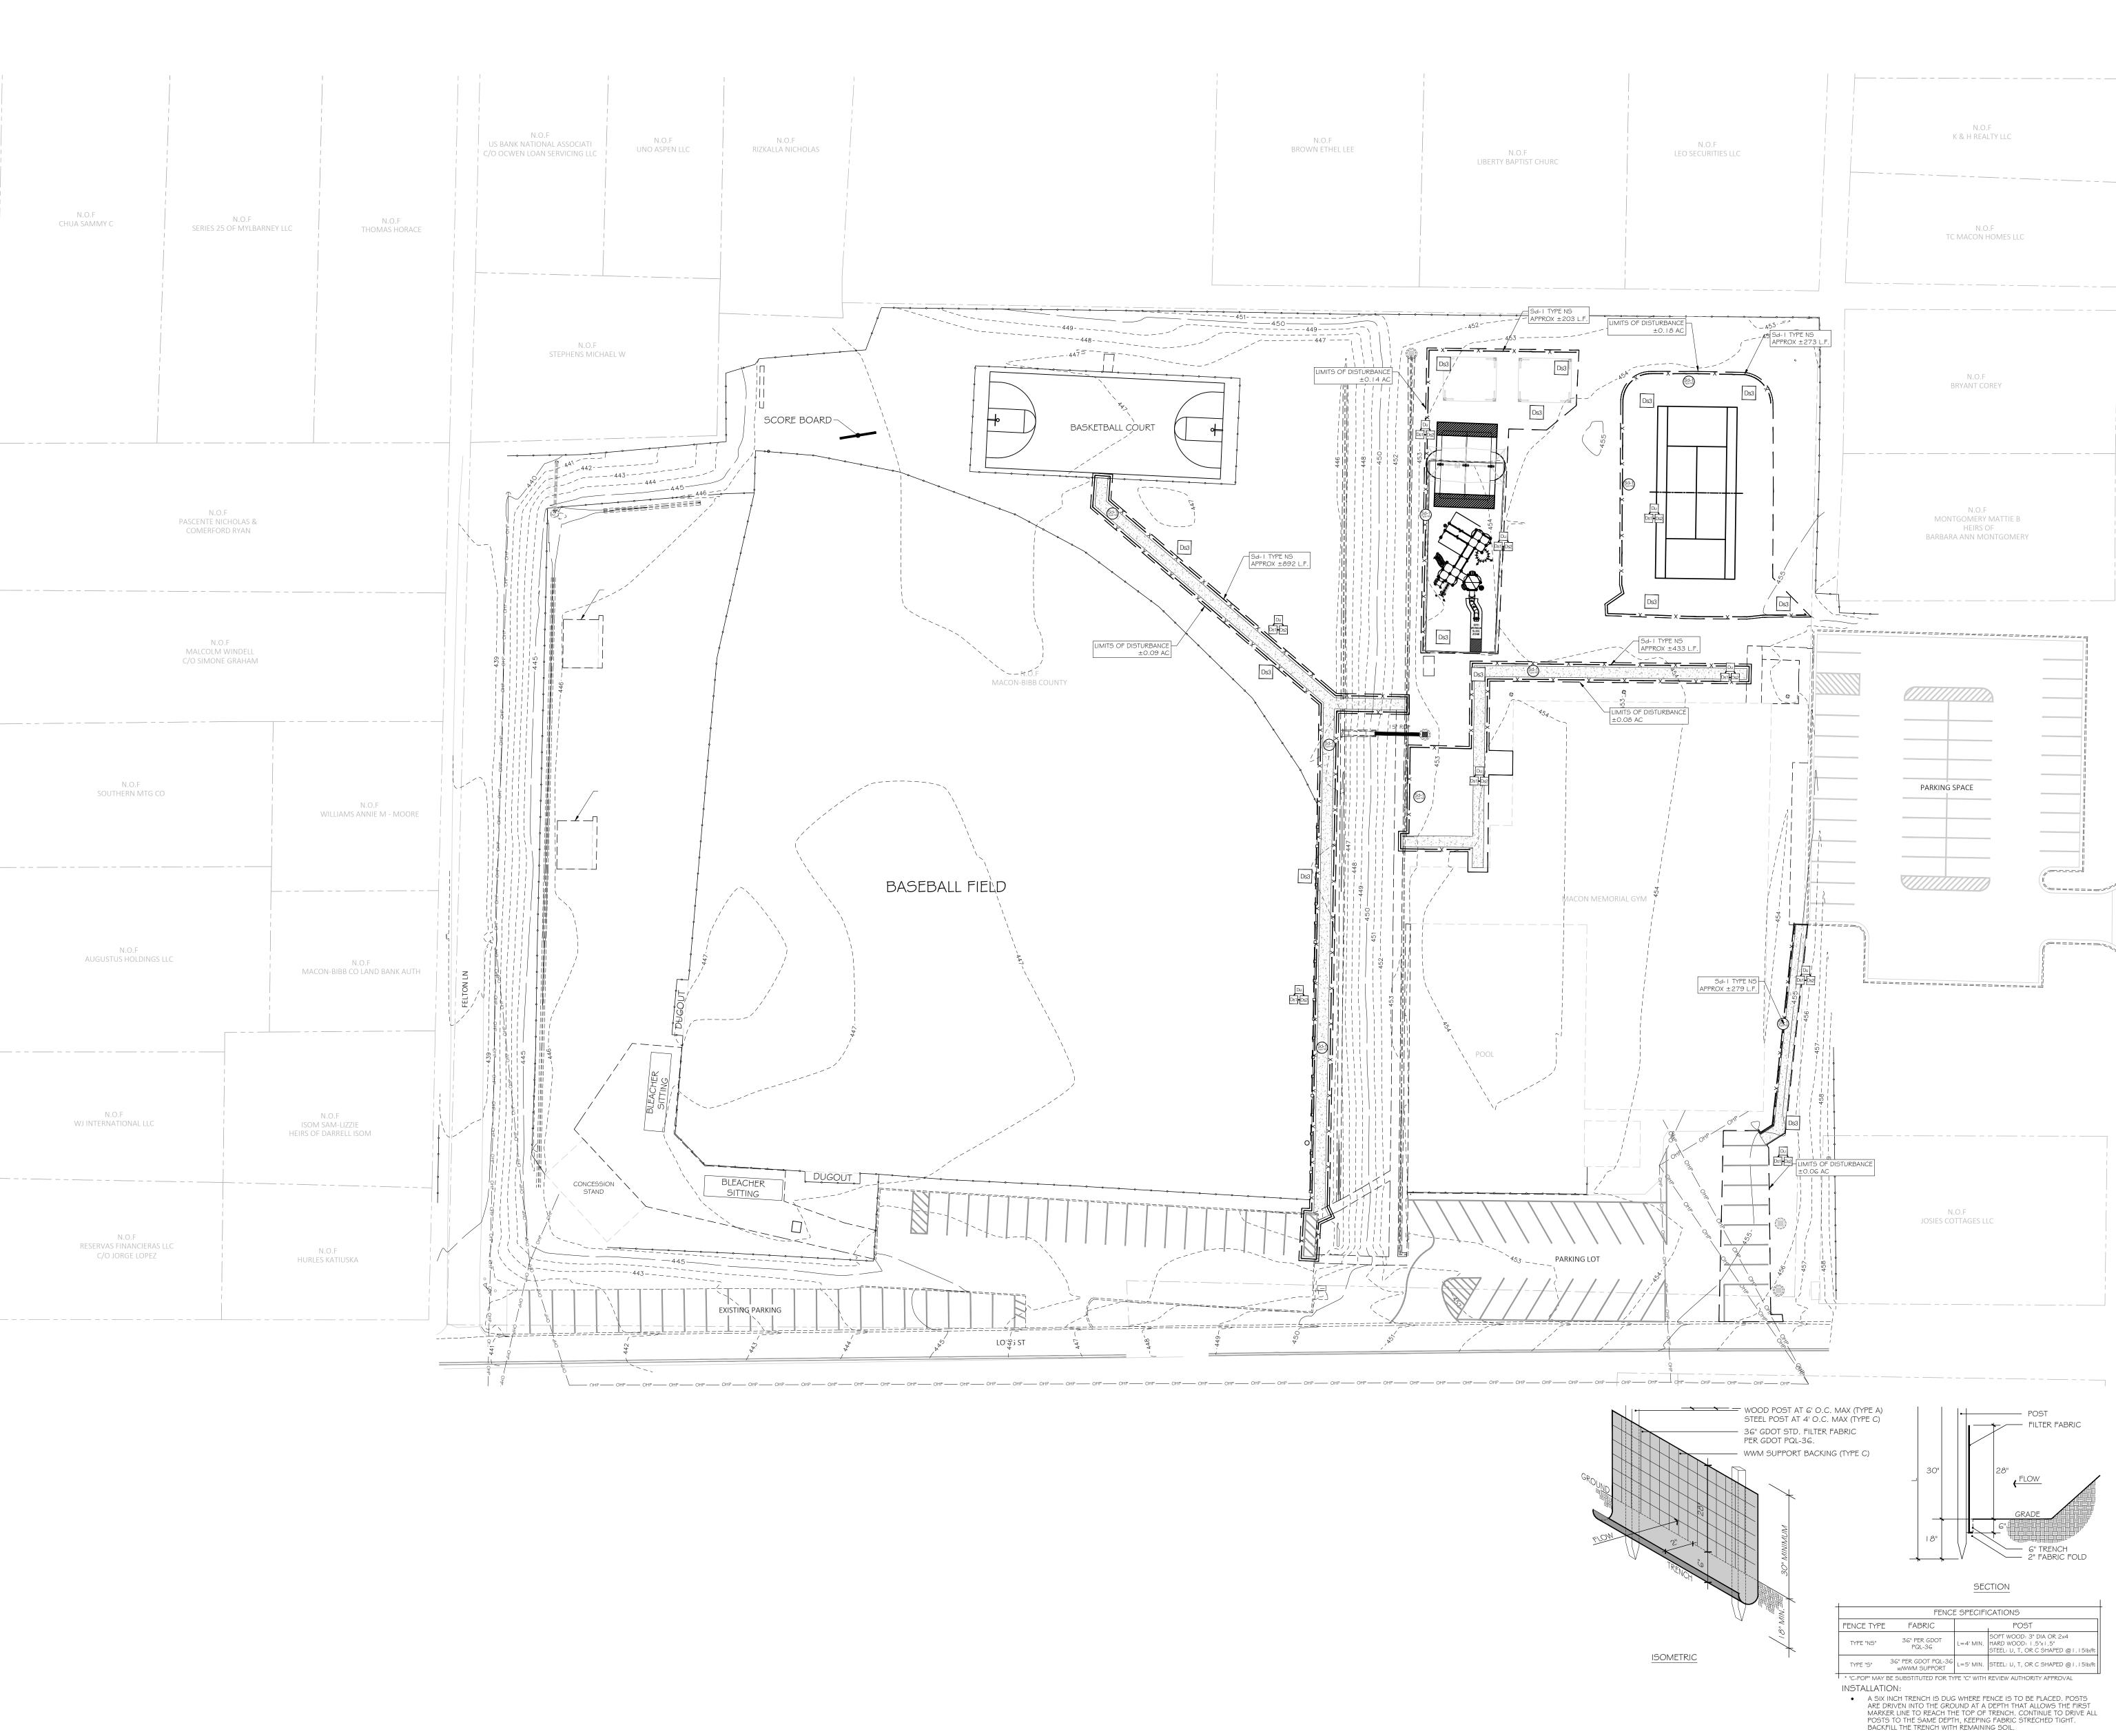



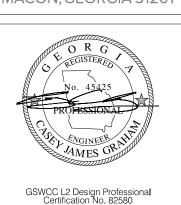





MEMORIAL PARK RECREATION CENTER RENOVATION

2465 2nd St, Macon, GA 31206

These drawings convey certain contractual information through the use of color. Do NOT use drawings printed in black-and-white or greyscale.

© 2023, WMA Architects/Planners, Inc. d/b/a WM2A Architects .
These drawings, as instruments of service, remain the property of the Architect.
Unauthorized use or reproduction is forbidden.

Project Status: ISSUED FOR PERMIT

Revision No (if any): Revision Date:

Project No: Current Date:

SEDIMENT CONTROL FENCE

2024-079 10/30/24

Drawing Name:

rig No:

C401

GENERAL NOTES

B. DEAD DESIGN WIND LO DESIGN WIND LO DESIGN WIND LO DESIGN WIND EXP DESIGN WIND EXP DESIGN WIND EXP DESIGN WIND EXP	ADS ND SPEED (WIND SPEI EGORY POSURE CA PRESSUR	(VULT)ED (VASD) TEGORY "(20 PSF 15 PSF 109 MPH 84.5 MPH II "GC _{PI} " = ±0 JRES:
		A=EFF	ECTIVE V	VIND ARE	A (FT ²)
	ZONE	A=10	A=20	A=50	A=100
ROOF	1, 2e	+16 -33	+16 -33	+16 -28	+16
	2n, 2r, 3e	+16 -55	+16 -48	+16	+16
	3r	+16 -65	+16 -54	+16 -40	+16
OVERHANG	1, 2e	-44	-44	-42	-41
	2n, 2r	-66	-61	-55	-51
	3e	-79	-68	-53	-53
	3r	-87	-74	- 57	-45
) "a	\$ 4 \$ "a"	"a"	H "a"	

ALL PRESSURES ARE INTENDED TO BE APPLIED AND INTERPRETED IN STRICT ACCORDANCE WITH ASCE 7-16. FOR THE PURPOSES OF APPLYING THESE LOADS

		NCE WITH COMPONENTS & CLADDING FIGURES IN ASCE 7-1	
3.	<u>SEISMI</u> A. B.	IC DESIGN SEISMIC IMPORTANCE FACTOR MAPPED SPECTRAL RESPONSE ACCELERATIONS	. I =1.0 S _S =0.1 S ₁ =0.0
	C. D.	SITE CLASS "D" ASSUMED SPECTRAL RESPONSE COEFFICIENTSS	
	E. F.	SEISMIC DESIGN CATEGORY "B" BASIC LATERAL FORCE RESISTING SYSTEM: TIMBER FRAMES	<i>D</i> , C ,
	G. H. I. J.	DESIGN BASE SHEAR	Cs =0.
4.	CODES	a. FORCE PROCEDURE FOR SEISMIC DESIGN OF BUIST 15 INTERNATIONAL BUILDING CODE, 2018 ED. WITH LATEST CO	
	В. С.	AMENDMENTS. REINFORCED CONCRETE: ACI 318-14. ALL STEEL WORK SHALL COMPLY WITH APPLICABLE STAN OF THE AMERICAN INSTITUTE OF STEEL CONSTRUCTION, INCLUDING THE SPECIFICATION FOR THE DESIGN, FABRIC AND ERECTION OF STRUCTURAL STEEL FOR BUILDINGS, I EDITION AND THE AMERICAN WELDING SOCIETY'S STRUCTURED WELDING CODE, AWS D1.1-LATEST EDITION.	NDARI CATION LATES
5.	PERMA INSTAL	DE TEMPORARY BRACING OF STRUCTURAL FRAMING UNTI ANENT BRACING, ANCHORS, AND FRAMING ARE COMPLETE LLED. THE STRUCTURAL ELEMENTS ARE UNSTABLE UNTIL CTURE IS COMPLETED IN ACCORDANCE WITH THE PLANS.	LY
6.	SHOP I	DRAWINGS GENERAL NOTE: THE PLANS, SECTIONS, AND D DED AS PART OF THE CONTRACT DOCUMENTS SHALL NOT EPRODUCIBLE FORM AS PART OF THE SHOP DRAWINGS.	

SOIL PARAMETERS

FOOTINGS ARE DESIGNED FOR A MINIMUM ALLOWABLE SOIL BEARING PRESSURE OF 2500 POUNDS PER SQUARE FOOT. SPECIFIC SITE PREPARATION GUIDELINES MAY BE REQUIRED TO ACHIEVE THIS SOIL BEARING PRESSURE. IF SITE CONDITIONS DIFFER FROM THOSE INDICATED, THE DESIGN PROFESSIONAL SHALL BE NOTIFIED IMMEDIATELY. REFERENCE CIVIL GRADING AND DRAINAGE PLANS, DETAILS, AND SPECIFICATIONS. ALL FOUNDATION WORK SHALL BE DONE 'IN THE DRY'. SEE REFERENCED SOILS REPORT FOR PRE-CONSTRUCTION DRAINAGE REQUIREMENTS. IT IS THE RESPONSIBILITY OF THE CONTRACTOR TO VERIFY ALL EXISTING SITE CONDITIONS THROUGH AN INDEPENDENT SITE INVESTIGATION PRIOR TO COMMENCING WORK.

WOOD FRAMING GENERAL NOTES

COMPACTED FILL TO BE 4" OF COMPACTED GRADED AGGREGATE

ALL WOOD FRAMING SHALL BE S.Y.P. NO. 2 OR BETTER, EXCEPTIONS LVL FRAMING SHALL HAVE PROPERTIES EQUAL TO OR BETTER THAN Fb=2600 PSI, E=2.0E6 PSI ALL MEMBERS IN CONTACT WITH CONCRETE OR MASONRY SHALL BE PRESSURE TREATED. WOOD CONSTRUCTION CONNECTORS SHALL BE ANCHOR TYPE/SIZE SPECIFIED HEREIN OR EQUIVALENT ANCHOR WITH EQUAL OR BETTER ALLOWABLE CAPACITY FROM USP OR TAMLYN. UNLESS NOTED OTHERWISE, PROVIDE MAXIMUM RECOMMENDED NO. OF FASTENERS. FASTENERS TO BE MANUFACTURER'S SPECIFIED FASTENER TYPE/SIZE. INSTALL ALL CONNECTORS IN STRICT ACCORDANCE WITH

MANUFACTURER'S WRITTEN INSTRUCTIONS. DIMENSIONAL LUMBER CONNECTIONS NOT SPECIFICALLY CALLED OUT ON THESE DRAWINGS SHALL HAVE THE MINIMUM SIZE AND NUMBER OF FASTENERS AS REQUIRED IN CHAPTER 23 OF THE INTERNATIONAL BUILDING CODE, 2018 ED. WITH LATEST GA

STRUCTURAL STEEL **GENERAL NOTES**

ALL STRUCTURAL STEEL CONSTRUCTION SHALL CONFORM TO AISC 360-16 "SPECIFICATION FOR STRUCTURAL STEEL BUILDINGS" AND THE "CODE OF STANDARD PRACTICE FOR STEEL BUILDINGS AND BRIDGES".

ALL PLATE STEEL SHALL CONFORM TO ASTM A572 GR.50 (50 KSI YIELD STRENGTH). 3. BOLTS JOINING STEEL TO WOOD AND WOOD TO WOOD SHALL CONFORM TO ASTM A307. SHOP DRAWINGS PREPARED IN ACCORDANCE WITH THE LATEST "STRUCTURAL STEEL DETAILING MANUAL" OF AISC SHALL BE

SUBMITTED FOR APPROVAL. NO FABRICATION SHALL BEGIN UNTIL SHOP DRAWINGS ARE COMPLETED AND APPROVED. PROVIDE TEMPORARY BRACING OF STRUCTURAL FRAMING UNTIL ALL PERMANENT BRACING, ANCHORS, AND FRAMING ARE COMPLETELY INSTALLED. THE STRUCTURAL ELEMENTS ARE UNSTABLE UNTIL THE

STRUCTURE IS COMPLETED IN ACCORDANCE WITH THE PLANS.

REINFORCED CONCRETE GENERAL NOTES

1. ALL CONCRETE WORK SHALL CONFORM TO ACI 301, "SPECIFICATIONS FOR STRUCTURAL CONCRETE FOR BUILDINGS". DESIGN IS BASED ON ACI 318, "BUILDING CODE REQUIREMENTS FOR STRUCTURAL

CONCRETE SHALL BE NORMAL WEIGHT (150 PCF) AND SHALL DEVELOP A MINIMUM COMPRESSIVE STRENGTH OF 4000 PSI AT 28

SUBMIT CONCRETE MIX DESIGNS FOR REVIEW, IN ACCORDANCE WITH ACI 301 & 318 TO THE ARCHITECT AND TESTING AGENCY. THE PROPOSED MATERIALS AND MIX DESIGN SHALL BE FULLY

DOCUMENTED AND REVIEWED. RESPONSIBILITY FOR OBTAINING THE REQUIRED DESIGN STRENGTH IS THE CONTRACTOR'S. USE OF CALCIUM CHLORIDE, CHLORIDE IONS, OR OTHER SALTS IN CONCRETE IS NOT PERMITTED. THE AIR CONTENT AT THE POINT OF PLACEMENT SHALL BE PER ACI 318 TABLE 19.3.3.1 FOR MODERATE EXPOSURE (F1). HARD TROWELED

SLABS OR SLABS ON GRADE THAT WILL RECEIVED TOPPINGS SHALL

NOT RECEIVE AIR ENTRAINMENT UNLESS PERMITTED BY TOPPING MANUFACTURER. THE TESTING AGENCY SHALL SAMPLE AND TEST EACH 100 CU. YARDS OR FRACTION THEREOF OF EACH CLASS OF CONCRETE PLACED EACH DAY. SAMPLE CONCRETE IN ACCORDANCE WITH ASTM C172. PERFORM THE FOLLOWING TESTS IN ACCORDANCE WITH THE INDICATED STANDARD:

SLUMP: AIR CONTENT: ASTM C231 (NORMAL WEIGHT CONCRETE) ASTM C173 (LIGHT WEIGHT CONCRETE) COMPRESSIVE STRENGTH: ASTM C39, WITH ONE CYLINDER AT 7 DAYS, 2 CYLINDERS AT 28 DAYS, AND ONE SPECIMEN HELD IN RESERVE. CONCRETE TEMPERATURE: ASTM C1064

MOIST CURE CONCRETE WITH MOISTURE PROTECTIVE COVER FOR A MINIMUM OF 7 DAYS. HORIZONTAL CONSTRUCTION JOINTS ARE PERMITTED ONLY WHERE INDICATED. THE LOCATION OF VERTICAL CONSTRUCTION JOINTS SHALL BE APPROVED BY THE ARCHITECT. CONSTRUCTION JOINTS

ASTM C567

UNIT WEIGHT:

SHALL BE THOROUGHLY ROUGHENED BY MECHANICAL MEANS, CLEANED, AND CAULKED. REINFORCING STEEL SHALL CONFORM TO ASTM A615, GRADE 60, UNLESS NOTED OTHERWISE. TIE ALL REINFORCING STEEL AND EMBEDMENTS SECURELY IN PLACE PRIOR TO PLACING CONCRETE. PROVIDE SUFFICIENY SUPPORTS TO MAINTAIN THE POSITION OF REINFORCEMENT WITHIN SPECIFIED

TOLERANCES DURING ALL CONSTRUCTION ACTIVITIES. "STICKING" DOWELS INTO WET CONCRETE IS NOT PERMITTED. REINFORCING STEEL SHALL HAVE THE FOLLOWING CONCRETE COVER UNLESS NOTED OTHERWISE:

> CONCRETE CAST AGAINST EARTH (NOT FORMED): FORMED CONCRETE EXPOSED TO EARTH OR WEATHER #6 BARS THROUGH #12 BARS #5 BARS AND SMALLER

DO NOT PLACE PIPES EXCEEDING ONE-THIRD THE SLAB OR WALL THICKNESS WITHIN THE SLAB OR WALL UNLESS SPECIFICALLY

SHOWN AND DETAILED ON STRUCTURAL DRAWINGS. DO NOT WELD OR TACK WELD REINFORCING STEEL UNLESS APPROVED OR DIRECTED BY THE STRUCTURAL ENGINEER. EXTERIOR SLABS SHALL DRAIN FREELY WITH A MAXIMUM VARIATION FROM THE INDICATED PLANE OF 1/4" PER 1'-0".

PREFABRICATED WOOD TRUSSES GENERAL NOTES

TRUSS DIAGRAMS AND ROOF FRAMING PLAN ARE TO BE FOLLOWED FOR OVERALL DIMENSIONS AND GENERAL CONFIGURATION. SPECIFICS OF CONFIGURATION AND MEMBER SIZES ARE TO BE

DETERMINED BY TRUSS MANUFACTURER'S ENGINEER, WITH MINIMUM SIZES AS SPECIFIED BELOW. TRUSS DESIGN SHALL BE PERFORMED BY AN ENGINEER, EMPLOYED BY THE TRUSS MANUFACTURER AND LICENSED TO PRACTICE IN THE STATE OF GEORGIA. DESIGN CALCULATIONS AND SHOP DRAWINGS SHALL BEAR SAID ENGINEER'S SEAL.

CONFORM TO APPLICABLE STANDARDS OF THE 2018 INTERNATIONAL BUILDING CODE, WITH LATEST GEORGIA AMENDMENTS. AND THE TRUSS PLATE INSTITUTE, INCLUDING THE NATIONAL

DESIGN STANDARD FOR METAL PLATE CONNECTED WOOD TRUSS CONSTRUCTION. DEAD LOADS, SNOW LOADS, LIVE LOADS, ROOF LIVE LOADS, SEISMIC LOADS AND WIND LOADS (AND THEIR COMBINATIONS) ARE TO BE IN ACCORDANCE WITH THE ABOVE REFERENCED CODE. TRUSS TOP CHORD DL: TRUSS BOTTOM CHORD DL: 10 PSF TRUSS BOTTOM CHORD LL: 0 PSF

TRUSS TOP CHORD LL: MEMBER SIZES ARE TO BE DETERMINED BY TRUSS ENGINEER'S CALCULATIONS, BUT MINIMUM SIZES FOR TOP AND BOTTOM CHORDS AND SOME OTHER NOTED MEMBERS TO BE 2"x6". ALL

MEMBERS FOR ALL TRUSSES TO BE SOUTHERN YELLOW PINE, #2 OR BETTER GRADE. MINIMUM SIZES SHOWN ABOVE SHALL NOT PRECLUDE A COMPLETE DESIGN AND ANALYSIS OF THE ROOF SYSTEM AND INDIVIDUAL TRUSSES. MEMBER SIZES LARGER THAN THOSE SHOWN ABOVE

SHALL BE USED IF INDICATED BY TRUSS ENGINEER'S CALCULATIONS. ALL TRUSSES SHALL BE FABRICATED IN THE MANUFACTURER'S SHOP AND DELIVERED ASSEMBLED TO THE JOB SITE. TRUSSES SHALL BE LOADED AND UNLOADED ACCORDING TO LIFTING DIRECTIONS GIVEN BY THE TRUSS ENGINEER. "DUMPING" OF TRUSSES SHALL BE GROUNDS FOR REJECTION, AS WILL ANY OTHER DAMAGE CAUSED BY FABRICATION, TRANSPORTING OR HANDLING OF TRUSSES.

TRUSSES SHALL BE ERECTED BY THE MANUFACTURER'S REPRESENTATIVE AT THE DIRECTION OF THE TRUSS ENGINEER, EITHER IN PERSON OR BY SPECIFIC DIRECTIONS SHOWN ON SHOP

SHOP DRAWINGS MUST BE SUBMITTED TO THE ARCHITECT FOR REVIEW PRIOR TO COMMENCEMENT OF ANY FABRICATION. SHOP DRAWINGS SHALL SHOW ALL DETAILS, DIMENSIONS, SIZES AND DESIGN CALCULATIONS NECESSARY TO FABRICATE AND ERECT TRUSSES AND ALL ASSOCIATED ACCESSORIES.

ALL TRUSSES SHALL BE ANCHORED TO RESIST UPLIFT AND HORIZONTAL FORCES COMPUTED BY TRUSS ENGINEER AS SHOWN ON SHOP DRAWINGS. ALL ACCESSORIES AND ANCHORAGE TO BE FURNISHED & INSTALLED BY TRUSS MANUFACTURER.


SUITE 500, PO BOX 110 MACON, GEORGIA 31201





MACON-BIBB COUNTY PARKS AND RECREATION

MEMORIAL PARK RECREATION 2465 2ND ST. MACON, GA 31206

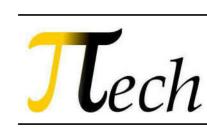


information through the use of color. Do NOT use drawings printed in black-and-white or greyscale. © 2023, WMA Architects/Planners, Inc. d/b/a WM2A Architects. These drawings, as instruments of service, remain the property of the Architect. Unauthorized use or reproduction is forbidden

These drawings convey certain contractual


Project Status: ISSUED FOR PERMIT Revision No (if any): Revision Date:

Project No: Current Date: 2024-079 10/30/24 Drawing Name:

GENERAL NOTES AND

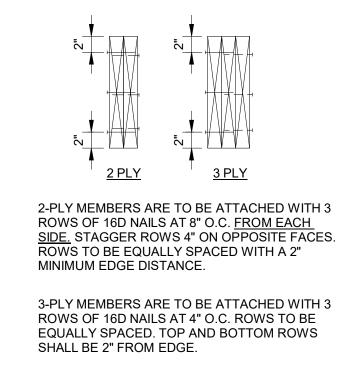


2 TYP. MULTI-PLY BEAM ATTACHMENT 1" = 1'-0"

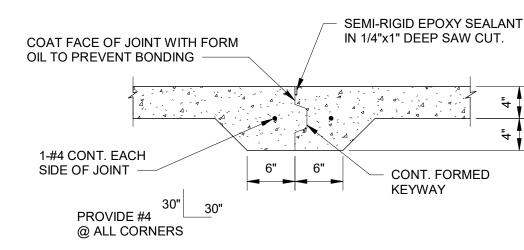

TYPICAL CONSTRUCTION JOINT (CJ) DETAIL

THIS DETAIL MAY BE USED AT THE CONTRACTOR'S DISCRETION

WHERE A CONSTRUCTION JOINT IN THE SLAB IS REQUIRED.

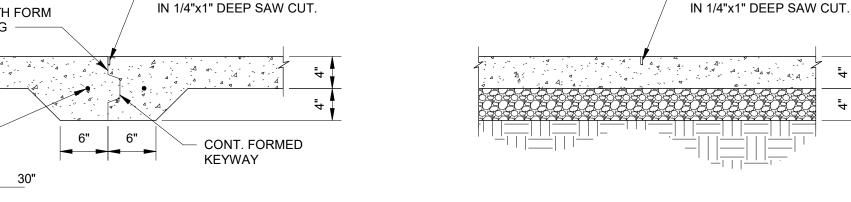


SAWCUT FLOOR JOINT (SCJ) DETAIL

SEMI-RIGID EPOXY SEALANT

THE SLAB MAY BE POURED MONOLITHICALLY (IN LIEU OF KEYED JOINTS) PROVIDED THAT THE JOINTS ARE CUT AS SOON AS THE SLAB CAN SUPPORT AN OPERATOR AND EQUIPMENT (BUT NO MORE THAN 4 HOURS AFTER THE POUR). SAW CUT JOINTS SHOULD BE A MIN. OF 1" DEEP FOR A 4" THICK SLAB AND SHALL BE LOCATED AT 15'-0" MAX. ON CENTER. JOINTS SHOULD BE LOCATED SUCH THAT THE SIDE RATIO OF EACH AREA DOES NOT EXCEED 3:2. HOWEVER A RATIO OF 1:1 IS PREFERRED. PROVIDE EITHER A SAW CUT JOINT OR 2-#5'S x 6'-0" AT ALL INTERIOR CORNERS. A CONT. CONSTRUCTION JOINT (KEYED) SHALL BE PROVIDED AT THE END OF EACH DAY'S POURING SEQUENCE.

CONCRETE SLAB ON GRADE JOINTING GENERAL NOTES AND DETAILS

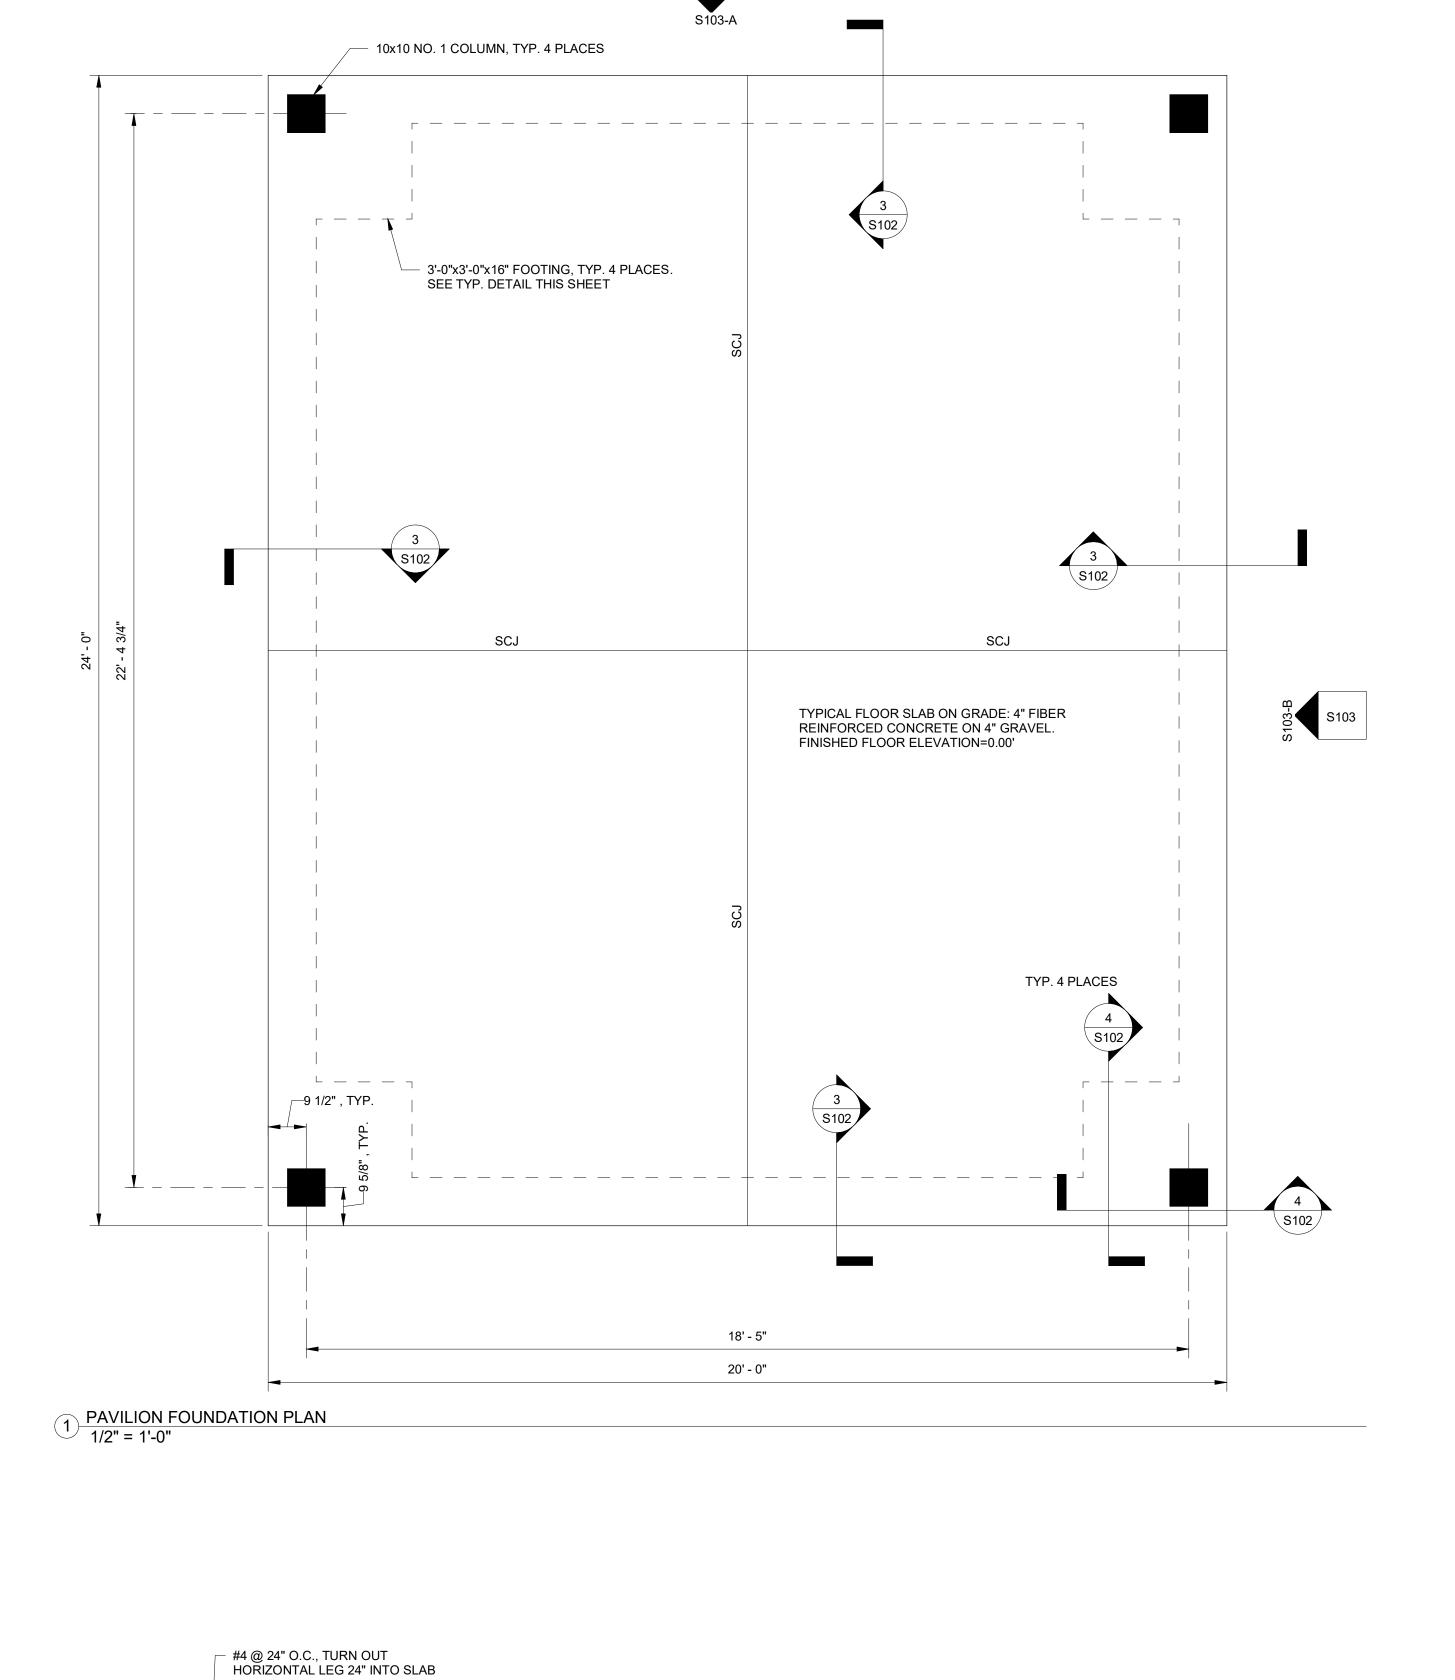

1' - 0"

SIMPSON RPBZ, TYP. @ 4 CORNERS ON EACH COLUMN. INSTALL PER MANUFACTURER'S SPECIFICATIONS WITH 3/8"Øx6" EMBED EXPANSION BOLTS.


3 TYP. TURNDOWN DETAIL 1" = 1'-0"


4 TYP. FOOTING DETAIL
1" = 1'-0"


10x10 NO. 1 COLUMN, SEE

PLAN FOR LOCATIONS -


(5)-#4 BARS EACH WAY, TYP. TOP AND BOTT.

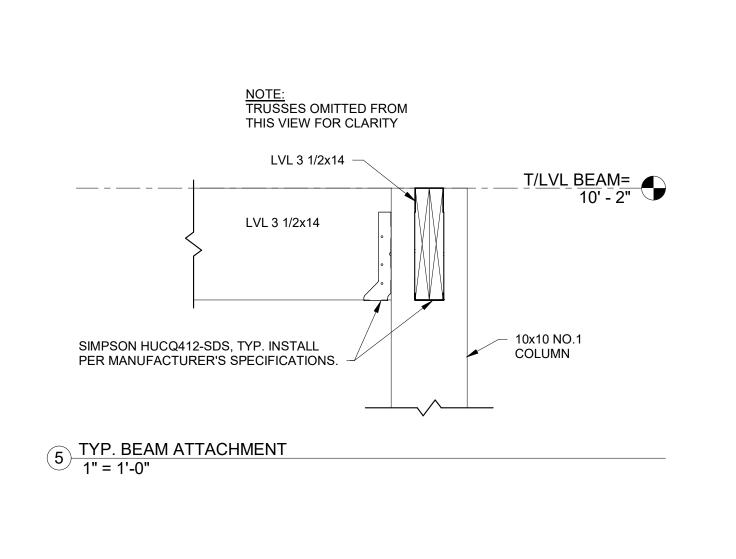

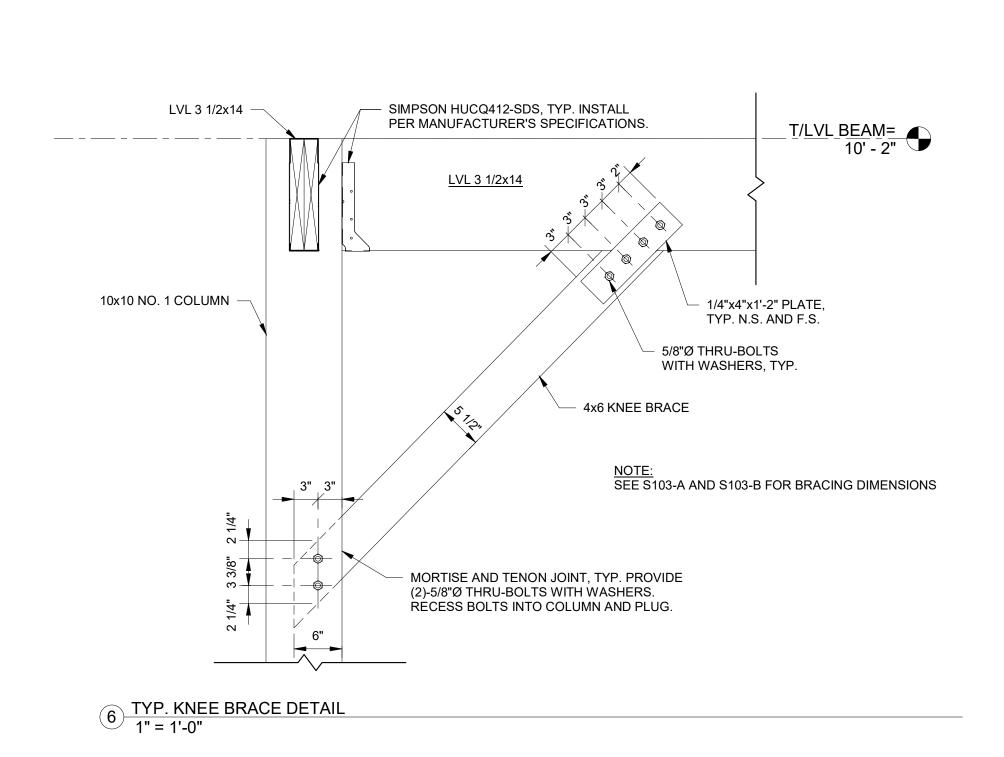

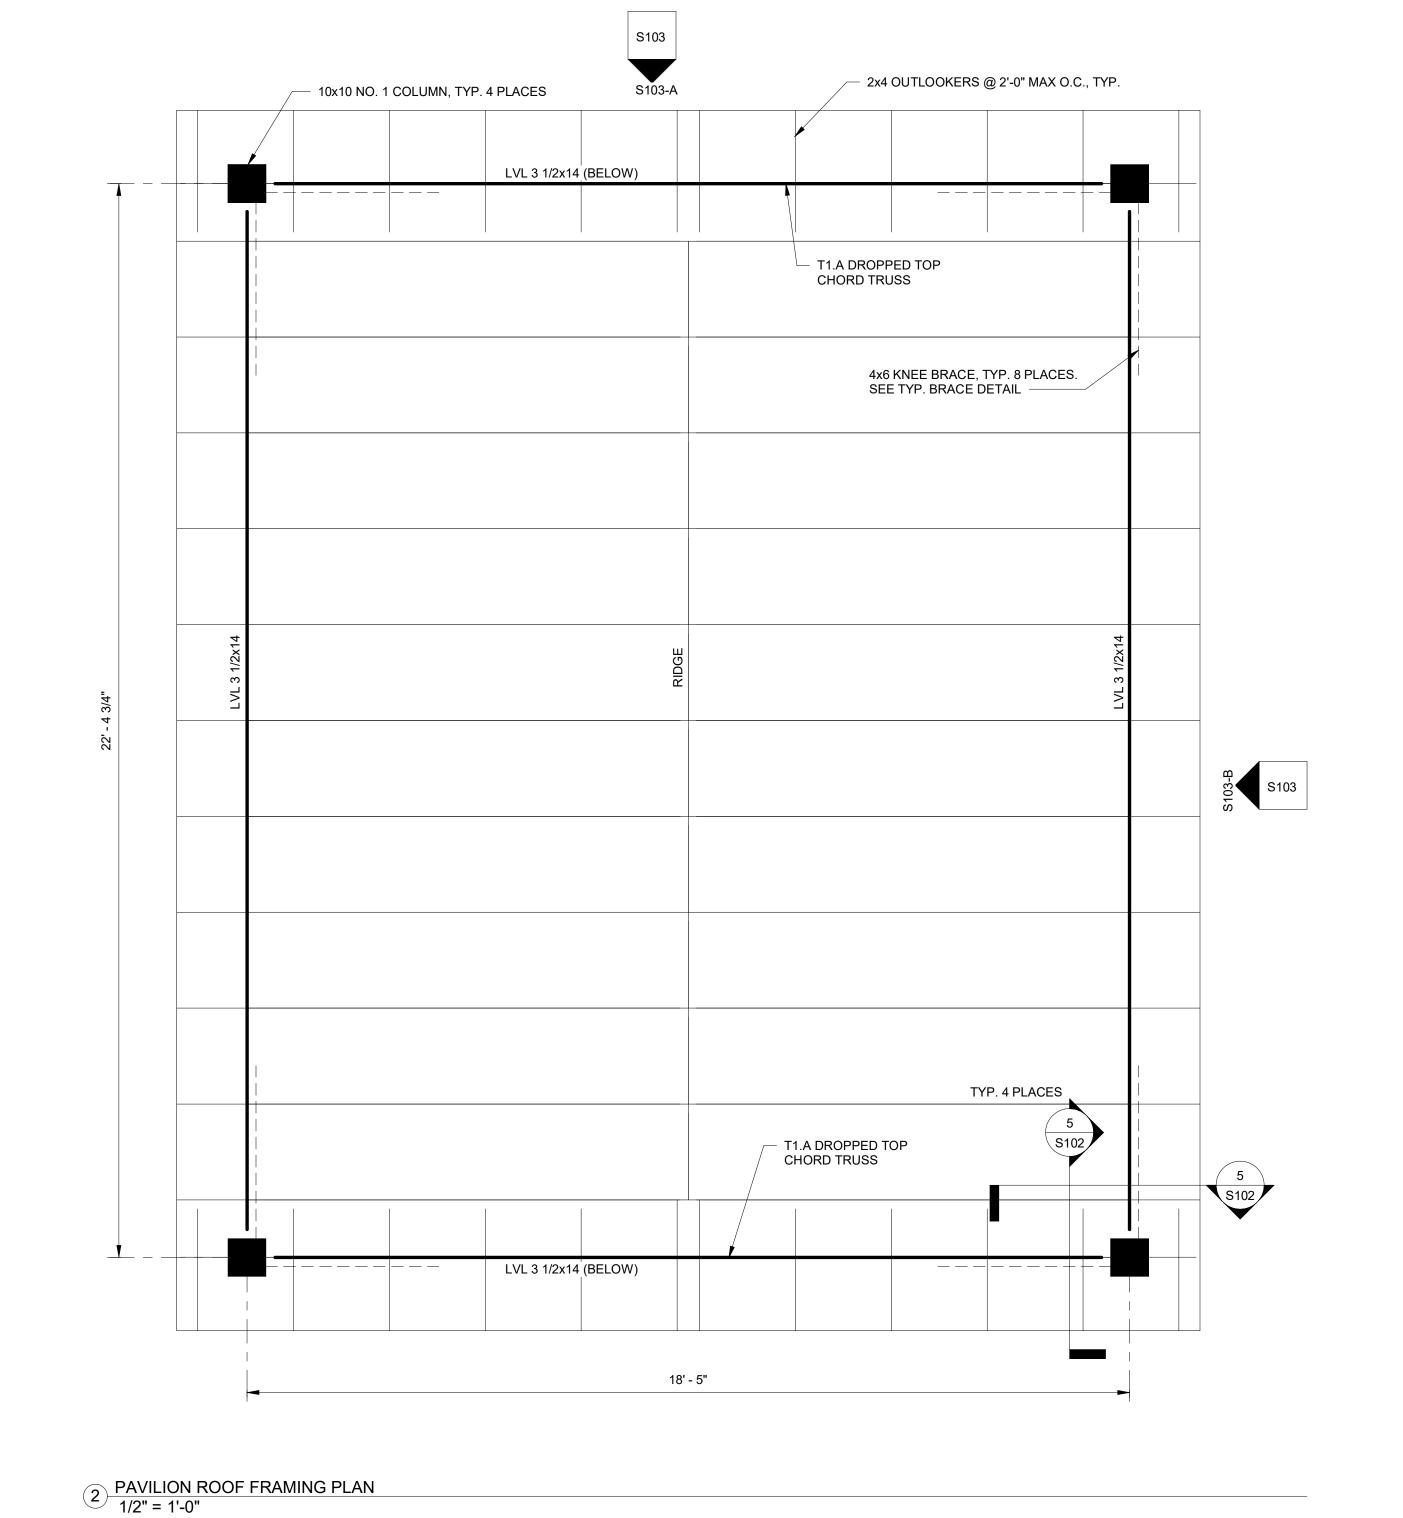



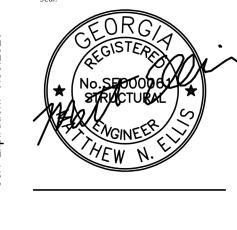

These drawings convey certain contractual information through the use of color. Do NOT use drawings printed in black-and-white or greyscale. © 2023, WMA Architects/Planners, Inc. d/b/a WMZA Architects.

These drawings, as instruments of service, remain the property of the Architect.

Unauthorized use or reproduction is forbidden Project Status: ISSUED FOR PERMIT Revision No (if any): Revision Date:

Project No: Current Date: 2024-079 10/30/24

Drawing Name:

FOUNDATION AND


FRAMING PLAN **S102**


MACON-BIBB COUNTY PARKS

MEMORIAL PARK RECREATION


AND RECREATION

CENTER RENOVATION 2465 2ND ST, MACON, GA 31206

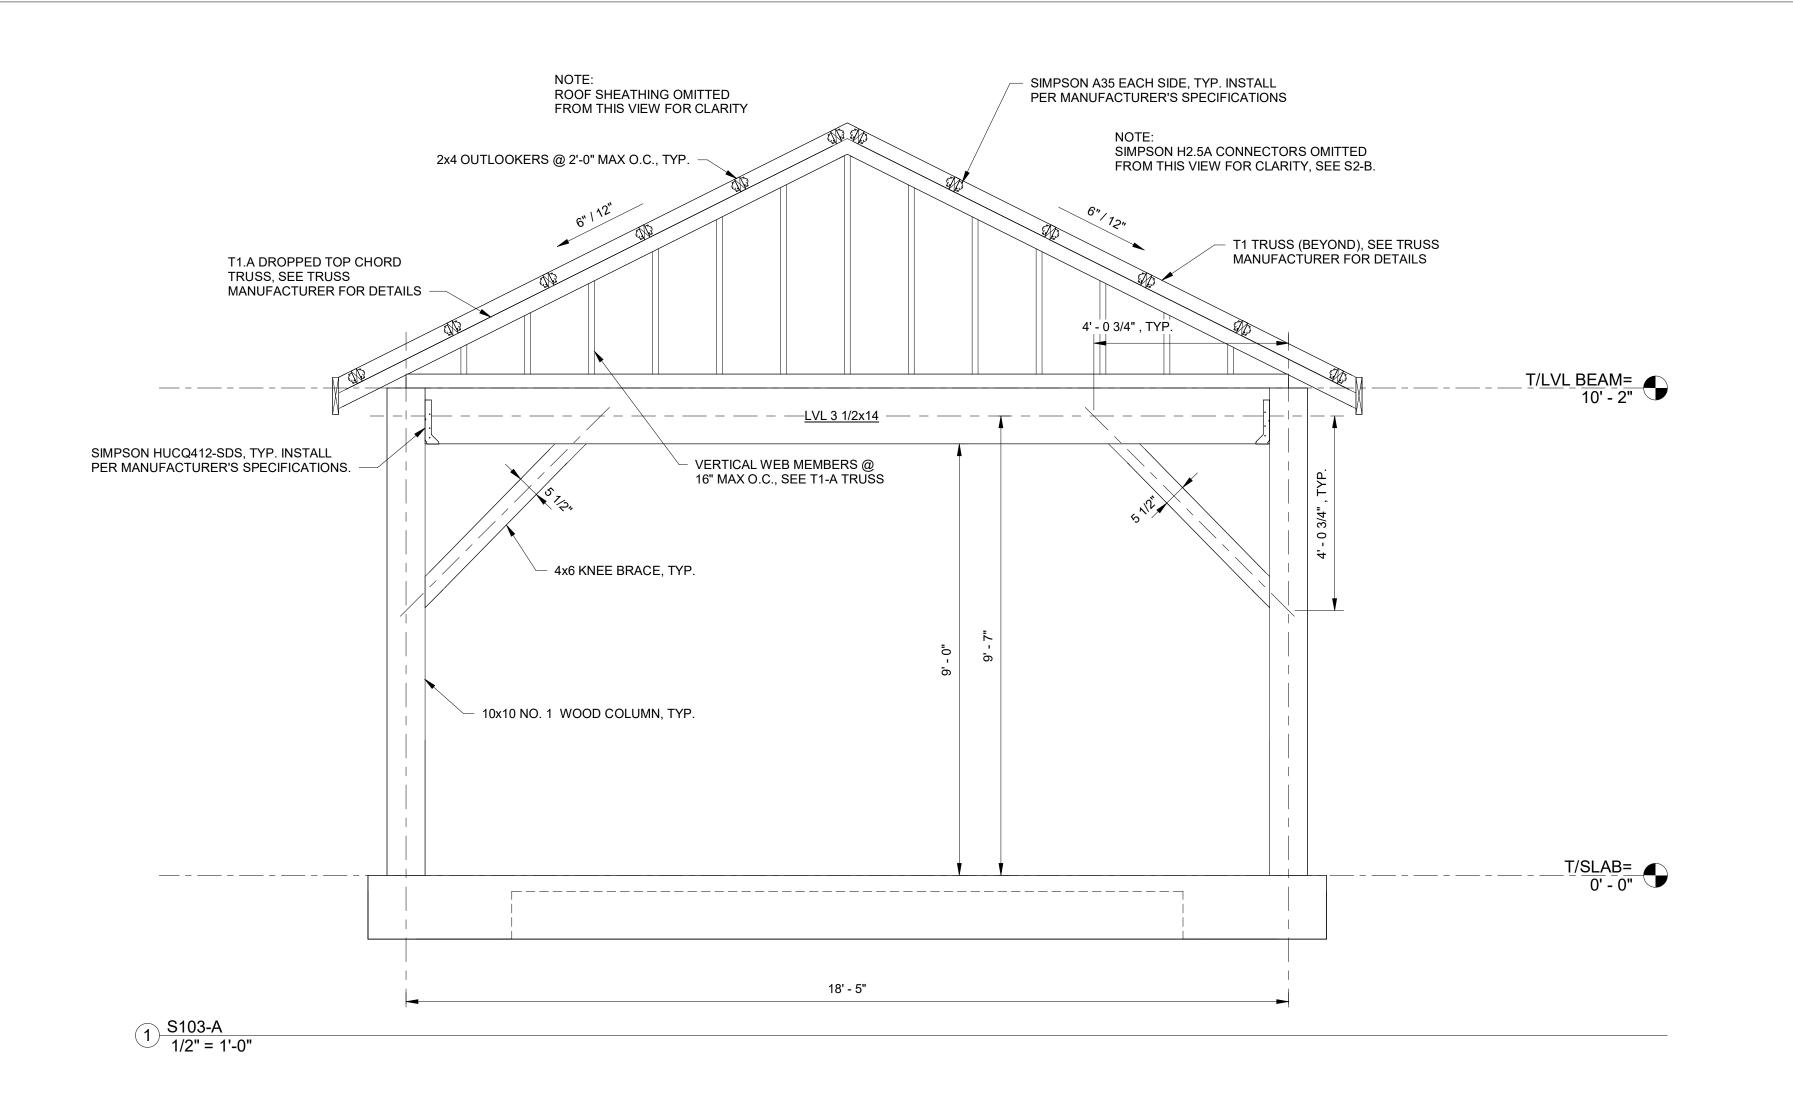

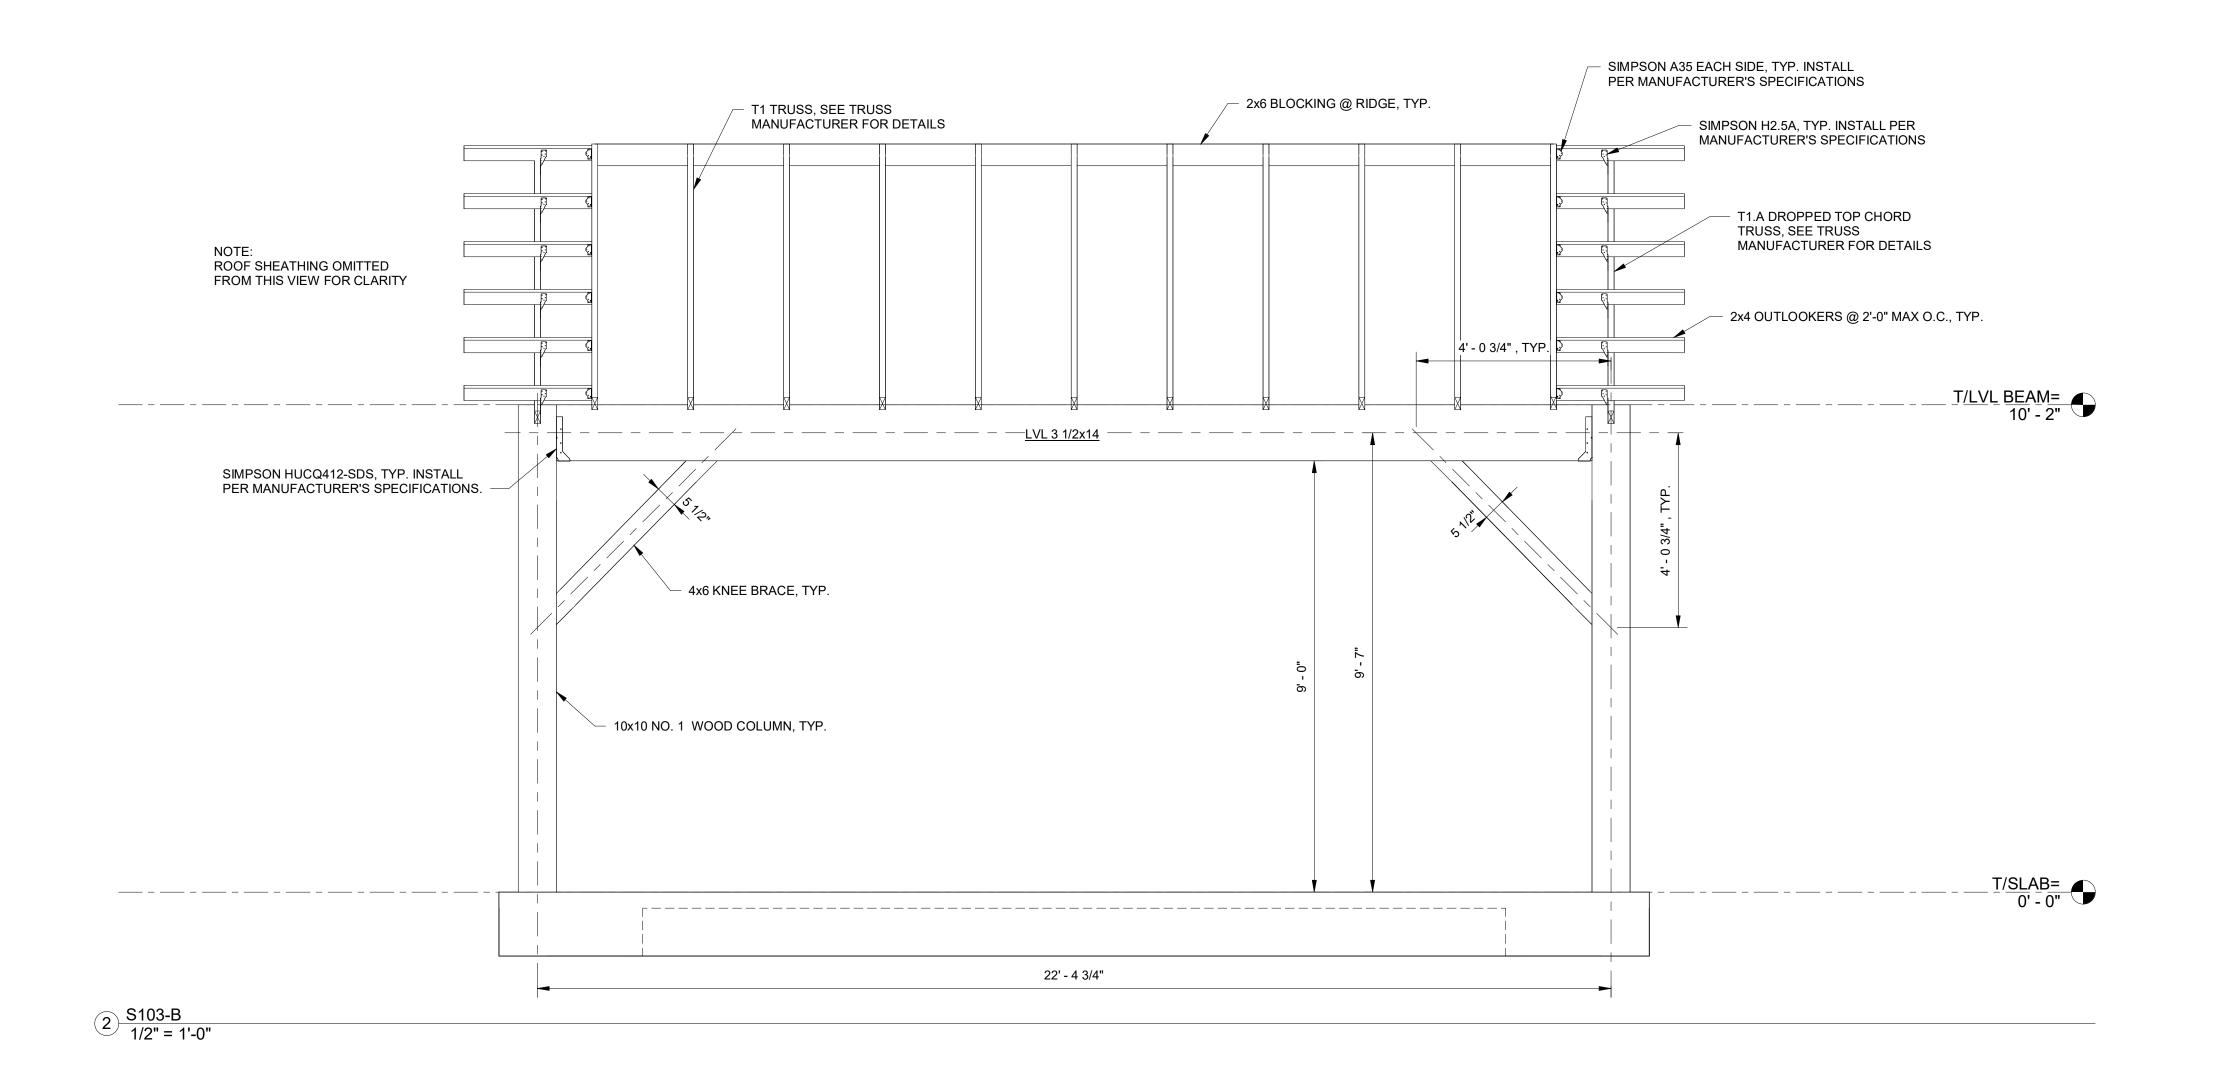



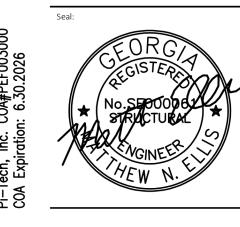



MEMORIAL PARK RECREATION CENTER RENOVATION 2465 2ND ST, MACON, GA 31206

Tech

These drawings convey certain contractual information through the use of color. Do NOT use drawings printed in black-and-white or greyscale.

© 2023, WMA Architects/Planners, Inc. d/b/a WM2A Architects.

These drawings, as instruments of service, remain the property of the Architect.

Unauthorized use or reproduction is forbidden.

remain the property of the Architect.
Unauthorized use or reproduction is forbidden.

Project Status:

ISSUED FOR PERMIT

Revision No (if any): Revision Date:


Project No: Current Date:


2024-079 10/30/24

Drawing Name:


BUILDING FLEVATIONS

Drawing No: \$103

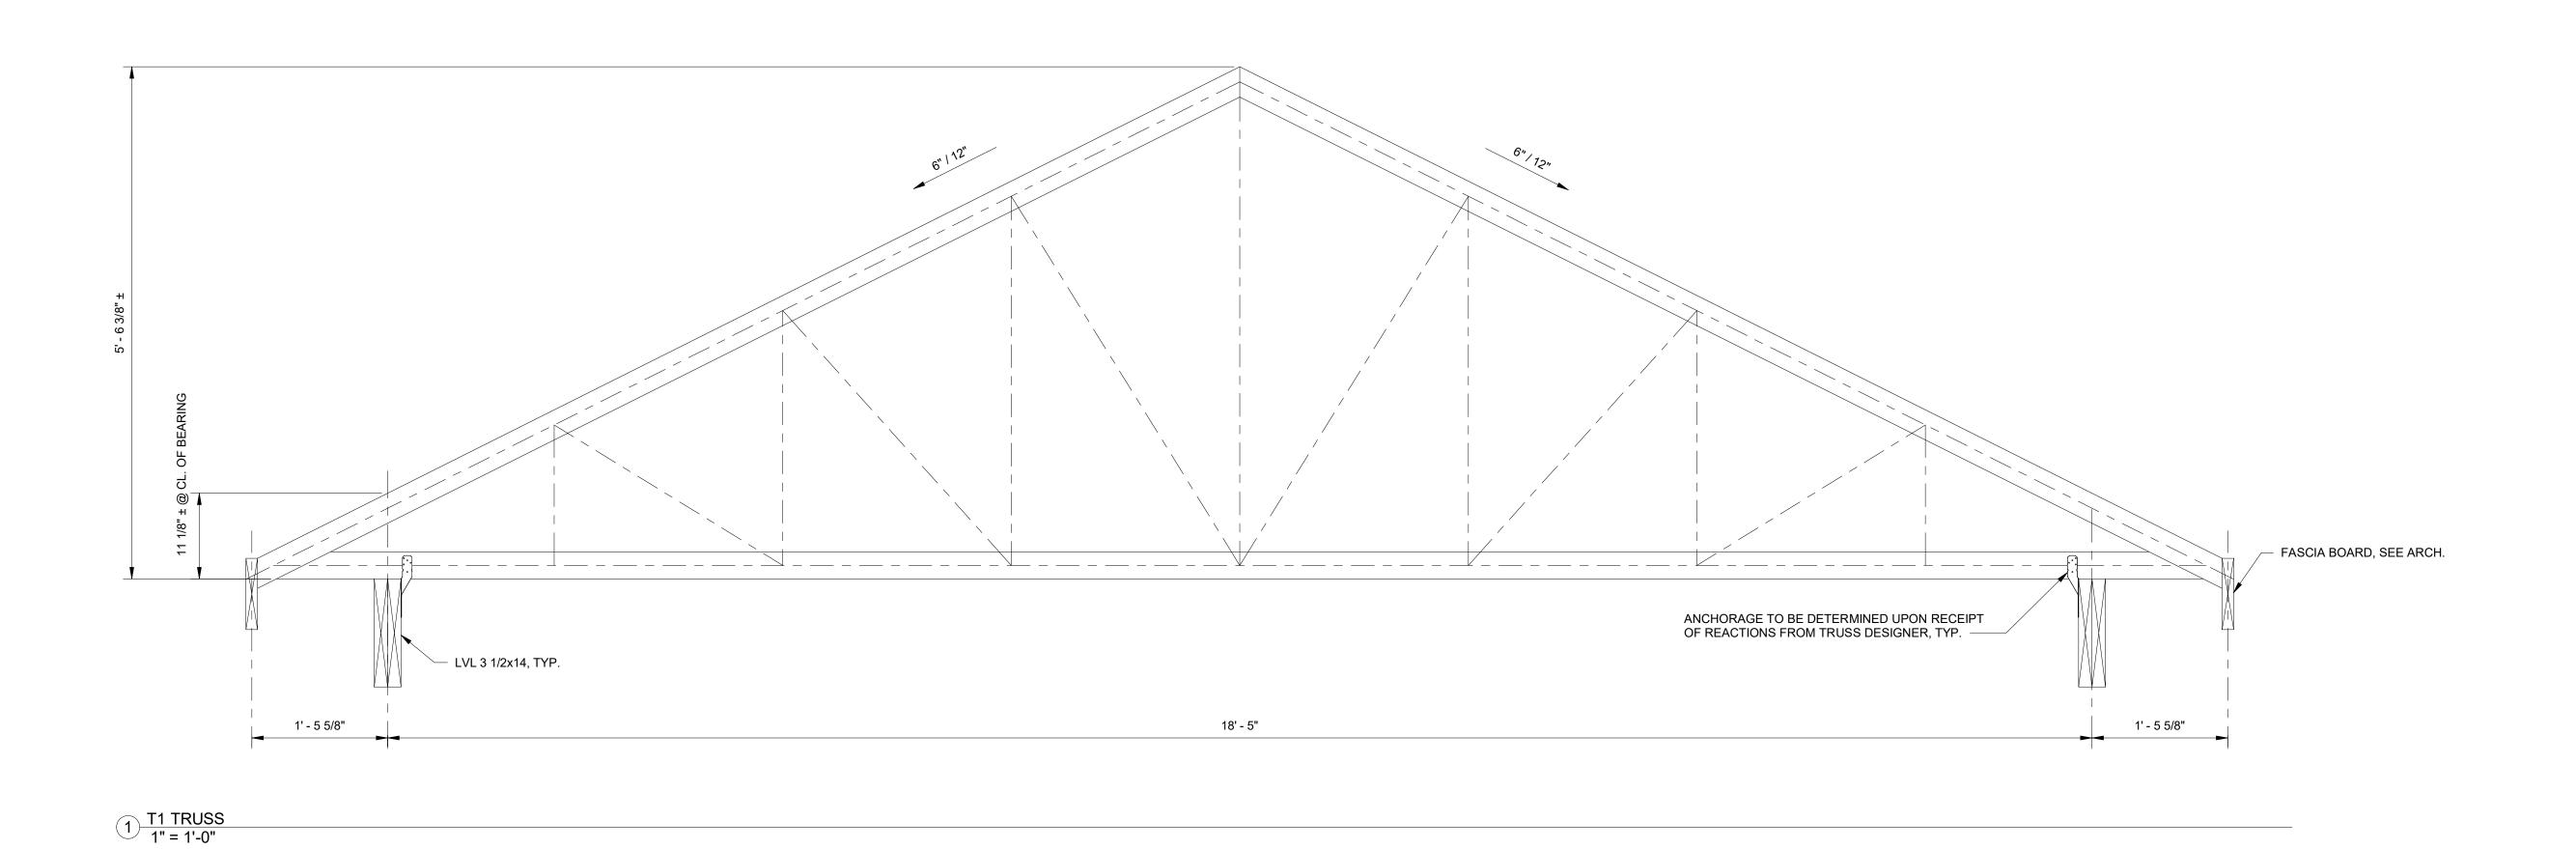

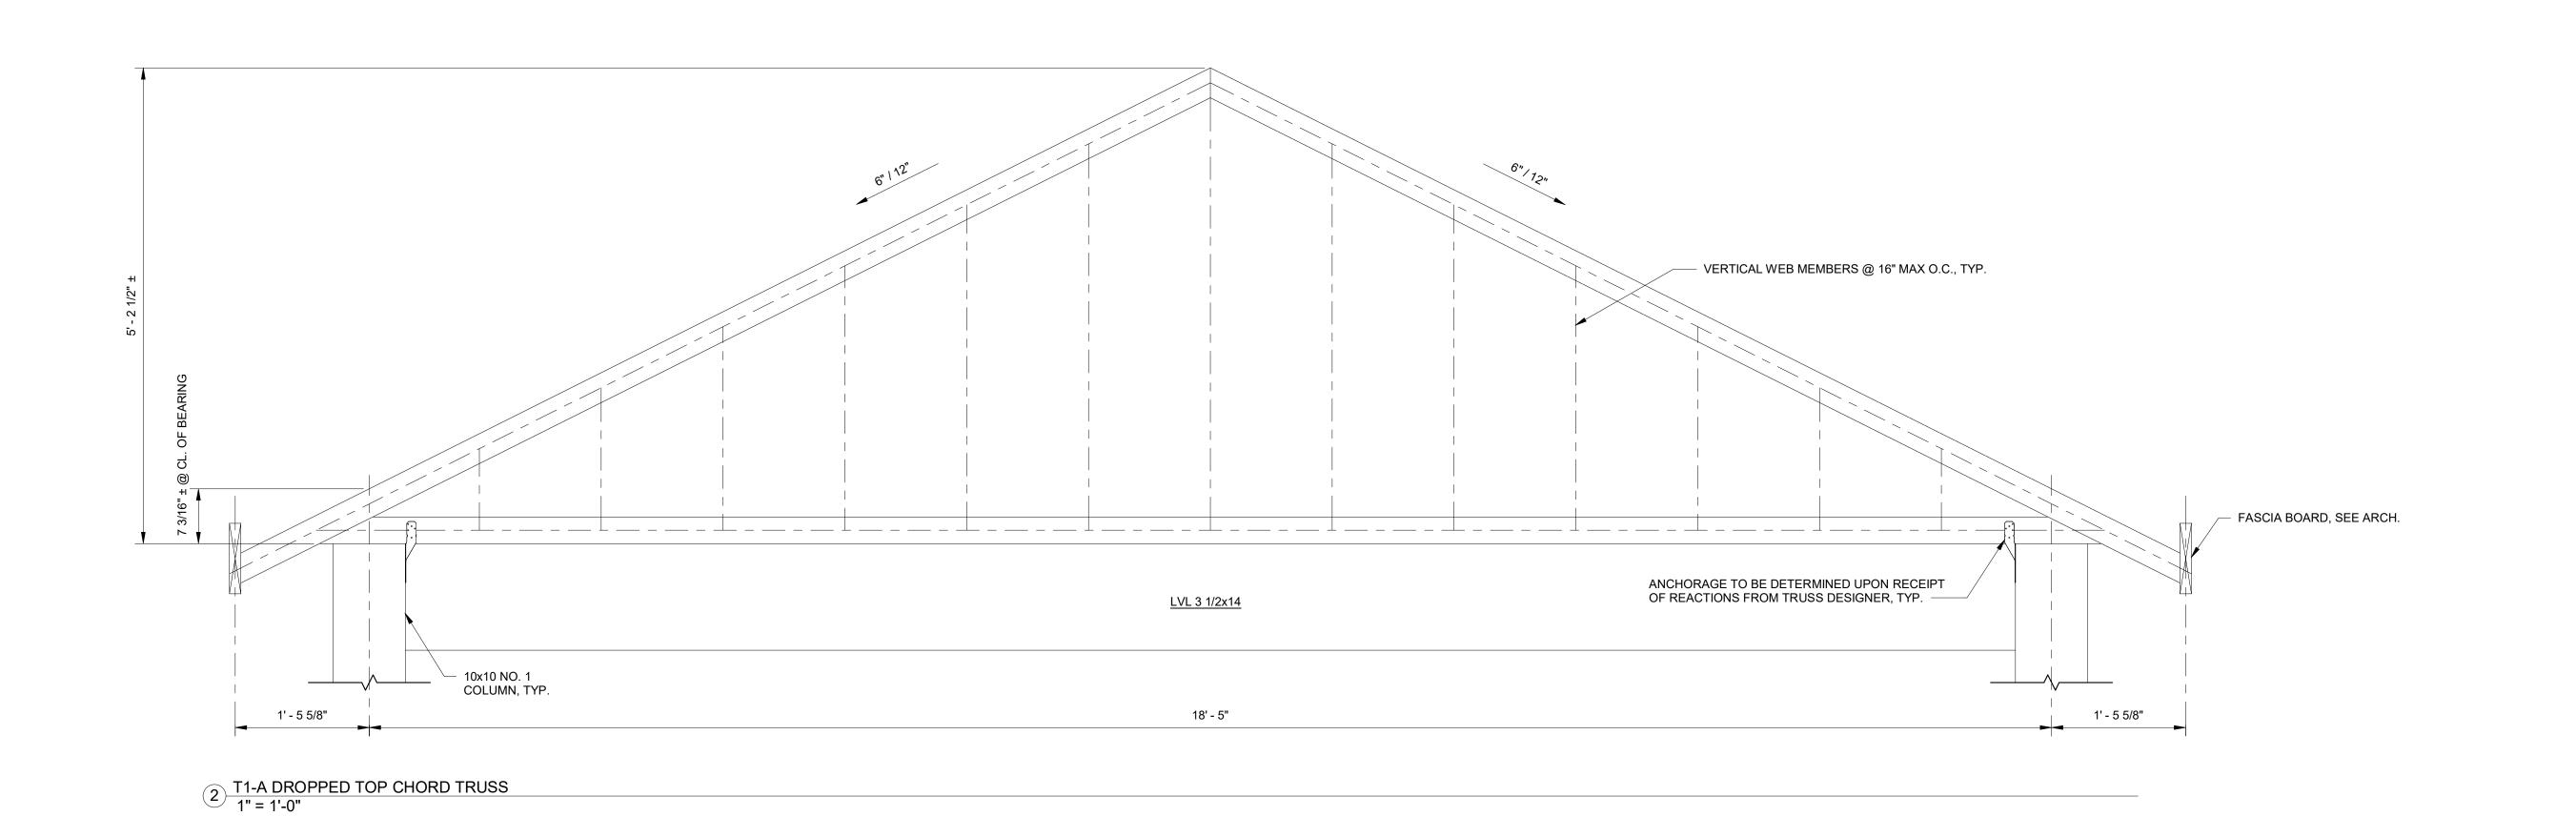



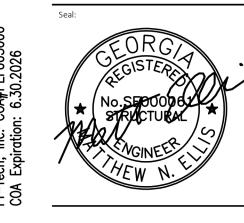



MEMORIAL PARK RECREATION CENTER RENOVATION
2465 2ND ST, MACON, GA 31206



These drawings convey certain contractual information through the use of color. Do NOT use drawings printed in black-and-white or greyscale.

© 2023, WMA Architects/Planners, Inc. d/b/a WM2A Architects.

These drawings, as instruments of service, remain the property of the Architect.

Unauthorized use or reproduction is forbidden.

Unauthorized use or reproduction is forbidden.

Project Status:

ISSUED FOR PERMIT

Revision No (if any): Revision Date:

Project No: Current Date:
2024-079 10/30/24

Drawing Name:

rawing Name:

S104

DIFF

DISP

DIV

DTL

DWMS DRYWALL METAL STUD (DIV 9)

INSIDE DIAMETER

INCLUDED; INCLUDING

INSULATED; INSULATION

JANITOR'S CLOSET

KIP (1000 POUNDS)

KNOCK DOWN

JOINT

INCH; INCHES

INFORMATION

INCAND INCANDESCENT

ROOF DRAIN

REFERENCE, REFRIGERATOR

RECESSED

REGISTER

RELOCATE

RESILIENT

ROOM

REMOVABLE

REQUIRE; REQUIRED


REVISION; REVISED

ROUGH OPENING

REINF REINFORCED; REINFORCING

RECPT RECEPTACLE


REQD REQUIRED

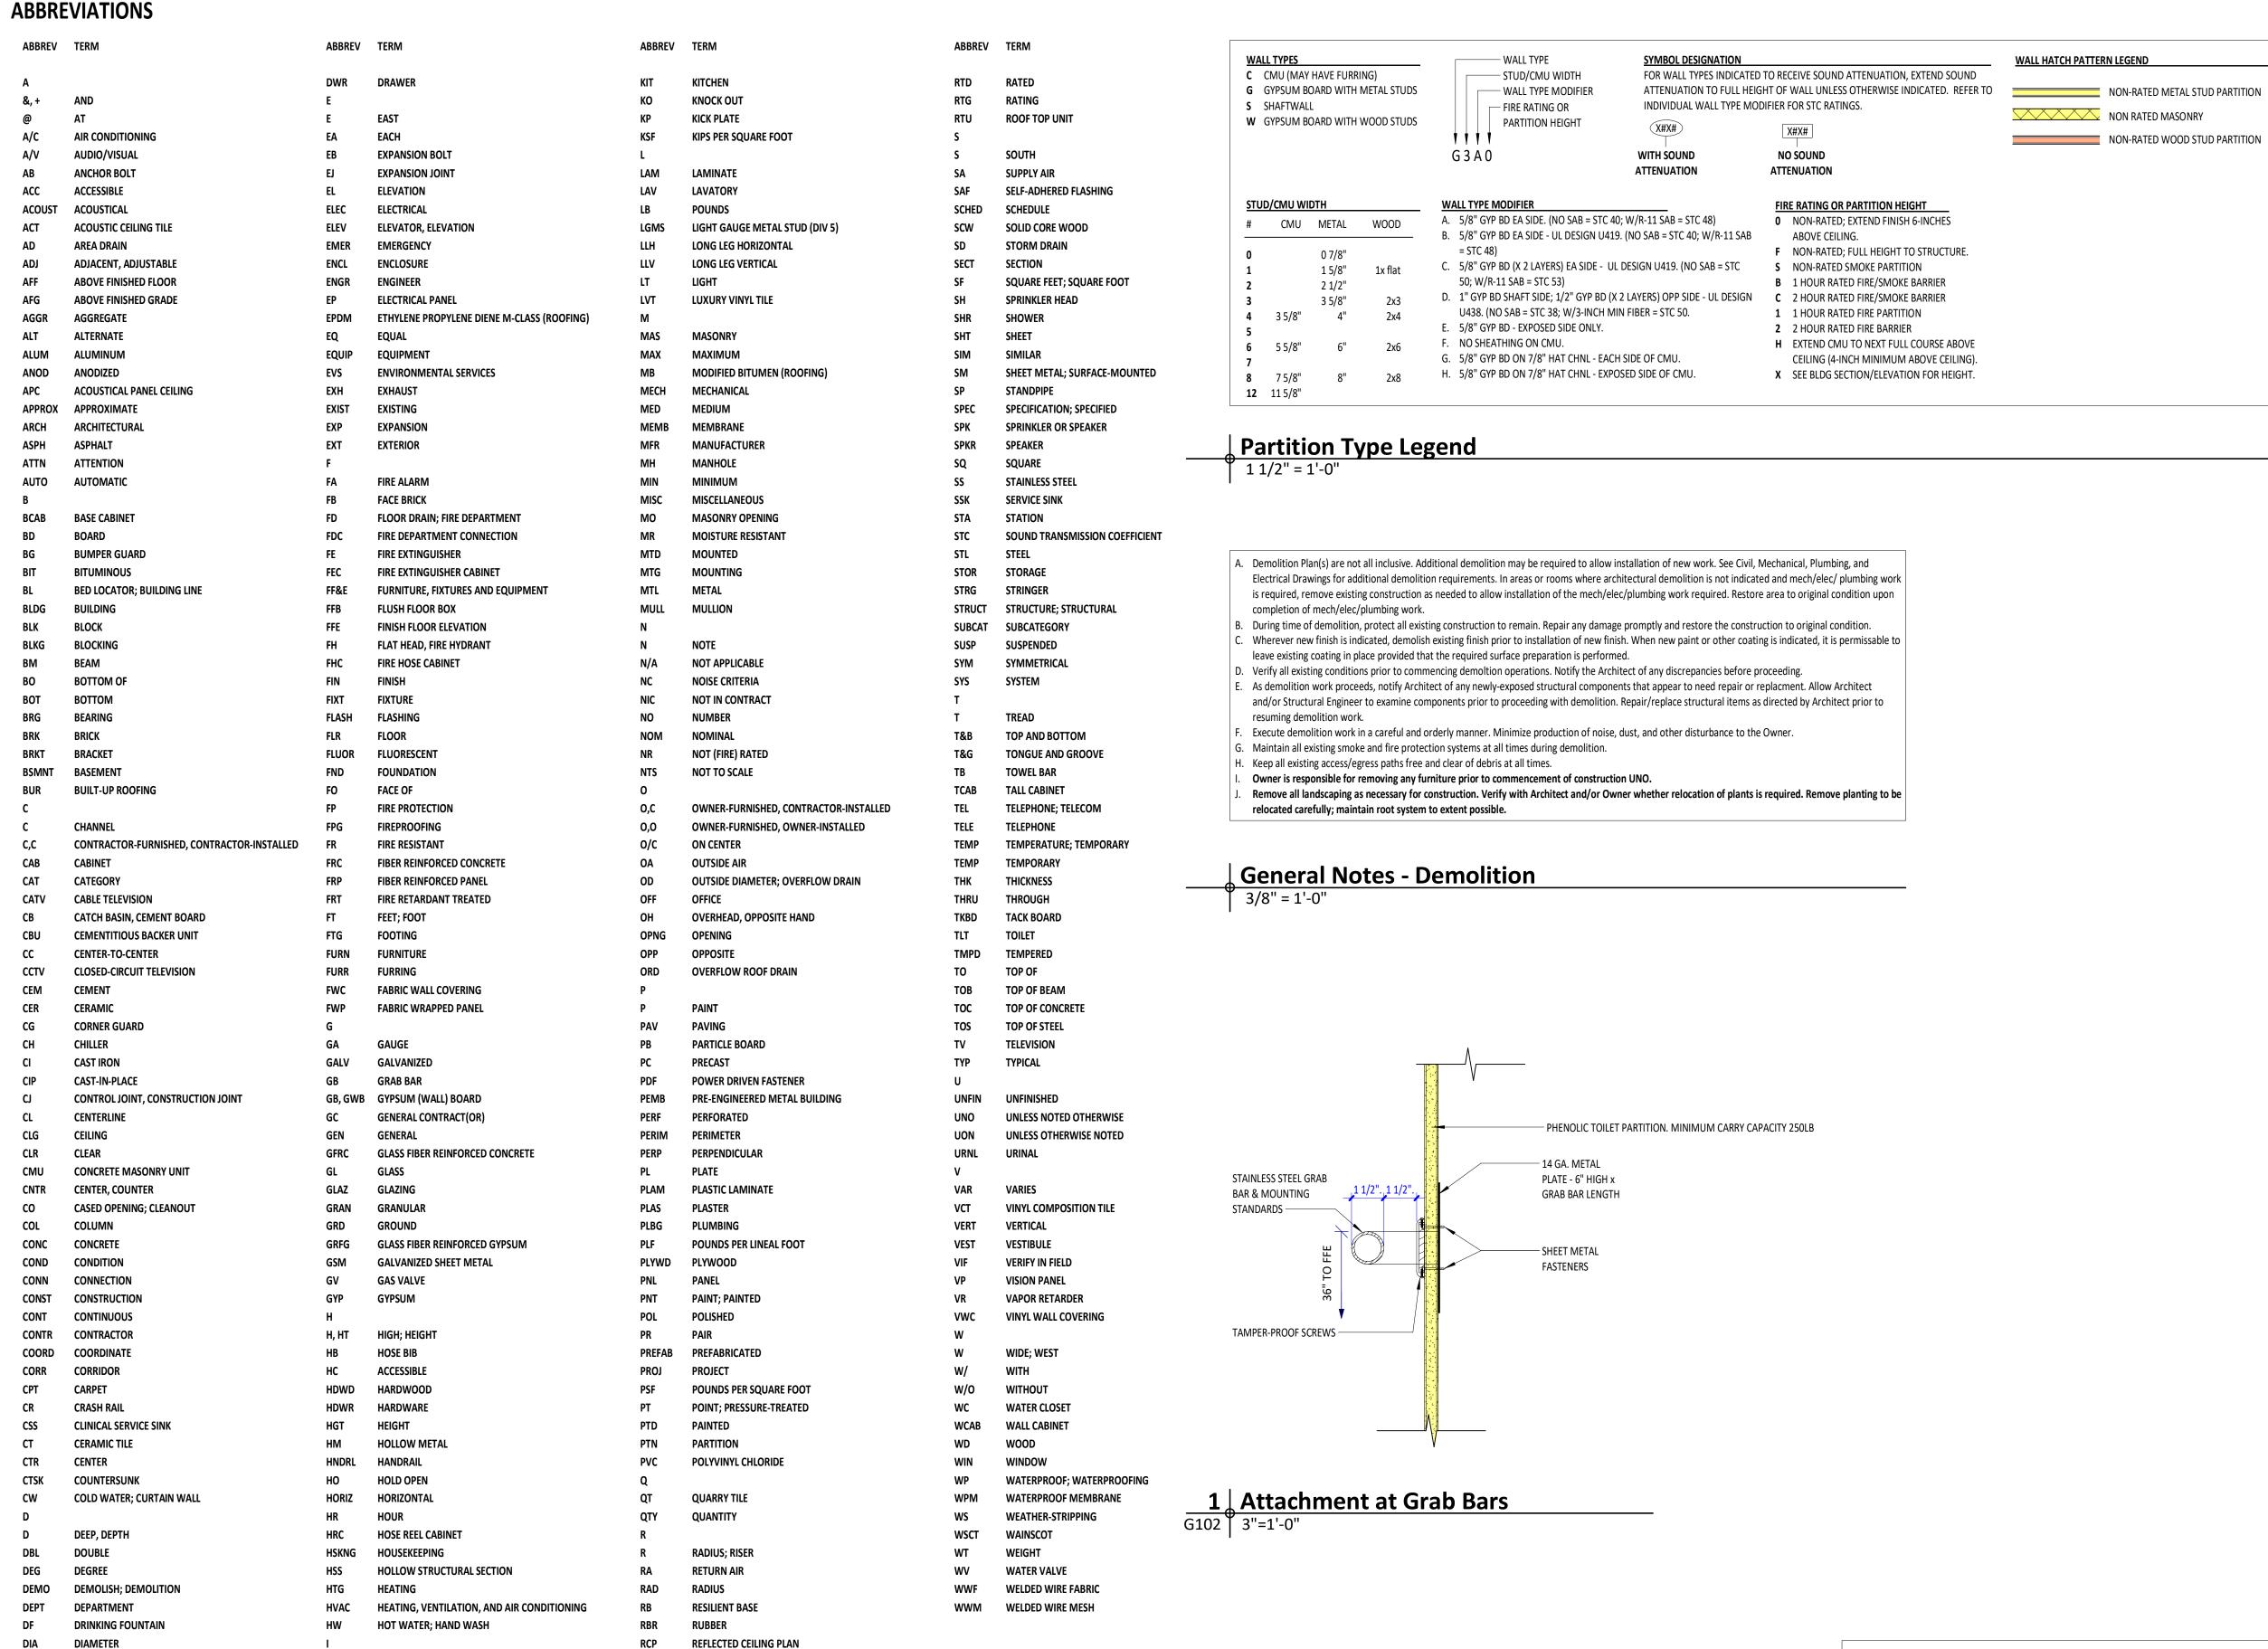

—Space Name -Space Number F1 - B1 - W1 —Floor finish - base finish - wall finish* - At light green background, provide sound attenuation batts at perimeter partitions. Fill full height of each partition. Ceiling type. Ceiling height above finished floor. Dot denotes face of finish. Slash denotes face of stud/face of CMU. — Nominal opening - width x height. WHG-HM1-HW-B90 Door type - Frame Type - HW Set - Fire Rating يَّ اللهِ ا (Denotes exterior elevation.) —Sheet Number 1 (A101) 1 — Elevation Number (Denotes interior elevation.) — Building Section Number —Sheet Number ∖ A101/− 1 SIM — Wall Section Number ∖ A101 ∕−− ----Sheet Number SIM Detail Section Number A101 /- Sheet Number —Callout Number Revision Number *At space indicator, finishes provide a shorthand view. Consult Finish Schedule for

> Symbol Legend 1 1/2" = 1'-0"

complete room finish requirements.

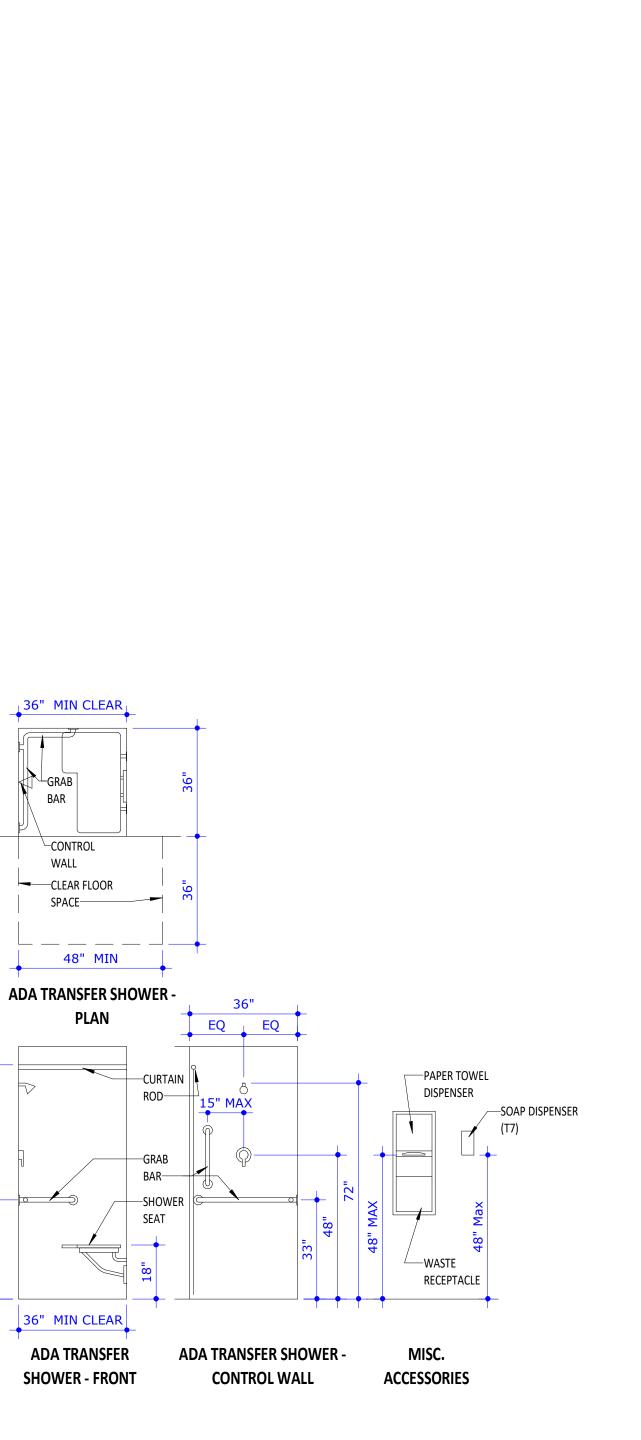

FIXTURE AND ACCESSORY MOUNTING NOTES:

60" MIN

TOILET TISSUE

36"_____

ADA TOILET

FRONT

DISPENSER (T10)

∕—GRAB BAR (T3)

ADA TOILET ROOM WITH ADJACENT

LAVATORY - PLAN

59" MIN CLEAR

GRAB BAR

ADA TOILET STALL- PLAN

ADA TOILET - SIDE

ADA Accessible Fixtures

42" MIN FOR

LATCH APPROACH

60" MIN FOR

HINGE SIDE APPROACH

—GRAB BAR

-NURSE CALL PULL

DISPENSER (T10)

STATION

TOILET TISSUE

NAPKIN DISPOSAL (T17)

DISPENSER (T10)

1. Install accessories at mounting heights indicated UNO.

3. Provide indicated clear floor space for all fixtures and accessories.

2. Provide partition blocking for wall-mounted items, such as grab bars. (See Partition Blocking detail.)

MIRROR

(T14/T15)

ADA LAVATORY -

FRONT

CLEAR FLOOR SPACE

----PIPE GUARD AT ALL ADA LAVS.

PIPES ARE

PROTECTED BY

CASEWORK.—

GUARD WHERE

ADA LAVATORY

SIDE

accommodations with the fabrication and installation of the toilet partition system.

5. Provide/install flush valve controls that are accessible from interior of room UNO.

4. Where accessories are indicated to be installed on or within toilet partitions, coordinate required fastening reinforcments, cutouts, and other required

CLEAR FLOOR SPACE—

ADA URINAL - PLAN

ADA URINAL

FRONT

SCREEN (IF

SCHEDULED)-

ADA URINAL -

SIDE

URINAL SCREEN

(IF INDICATED)—

These drawings convey certain contractual information through the use of color. Do NOT use drawings printed in black-and-white or grevscale. © 2023, WMA Architects/Planners, Inc. d/b/a WM2A Architects. These drawings, as instruments of service, remain the property of the Architect. Unauthorized use or reproduction is forbido Issued for Permit

348 COTTON AVENUE

SUITE 500, PO BOX 110

MACON, GEORGIA 31201

BRANDON A

FAIRBANKS

MACON-BIBB COUNTY PARKS

MEMORIAL PARK RECREATION

AND RECREATION

CENTER RENOVATION


2465 2ND ST, MACON, GA 31206

Project No: Current Date: 2024-079 10/30/24

Revision No (if any): Revision Date:

GENERAL REQUIREMENTS

G102

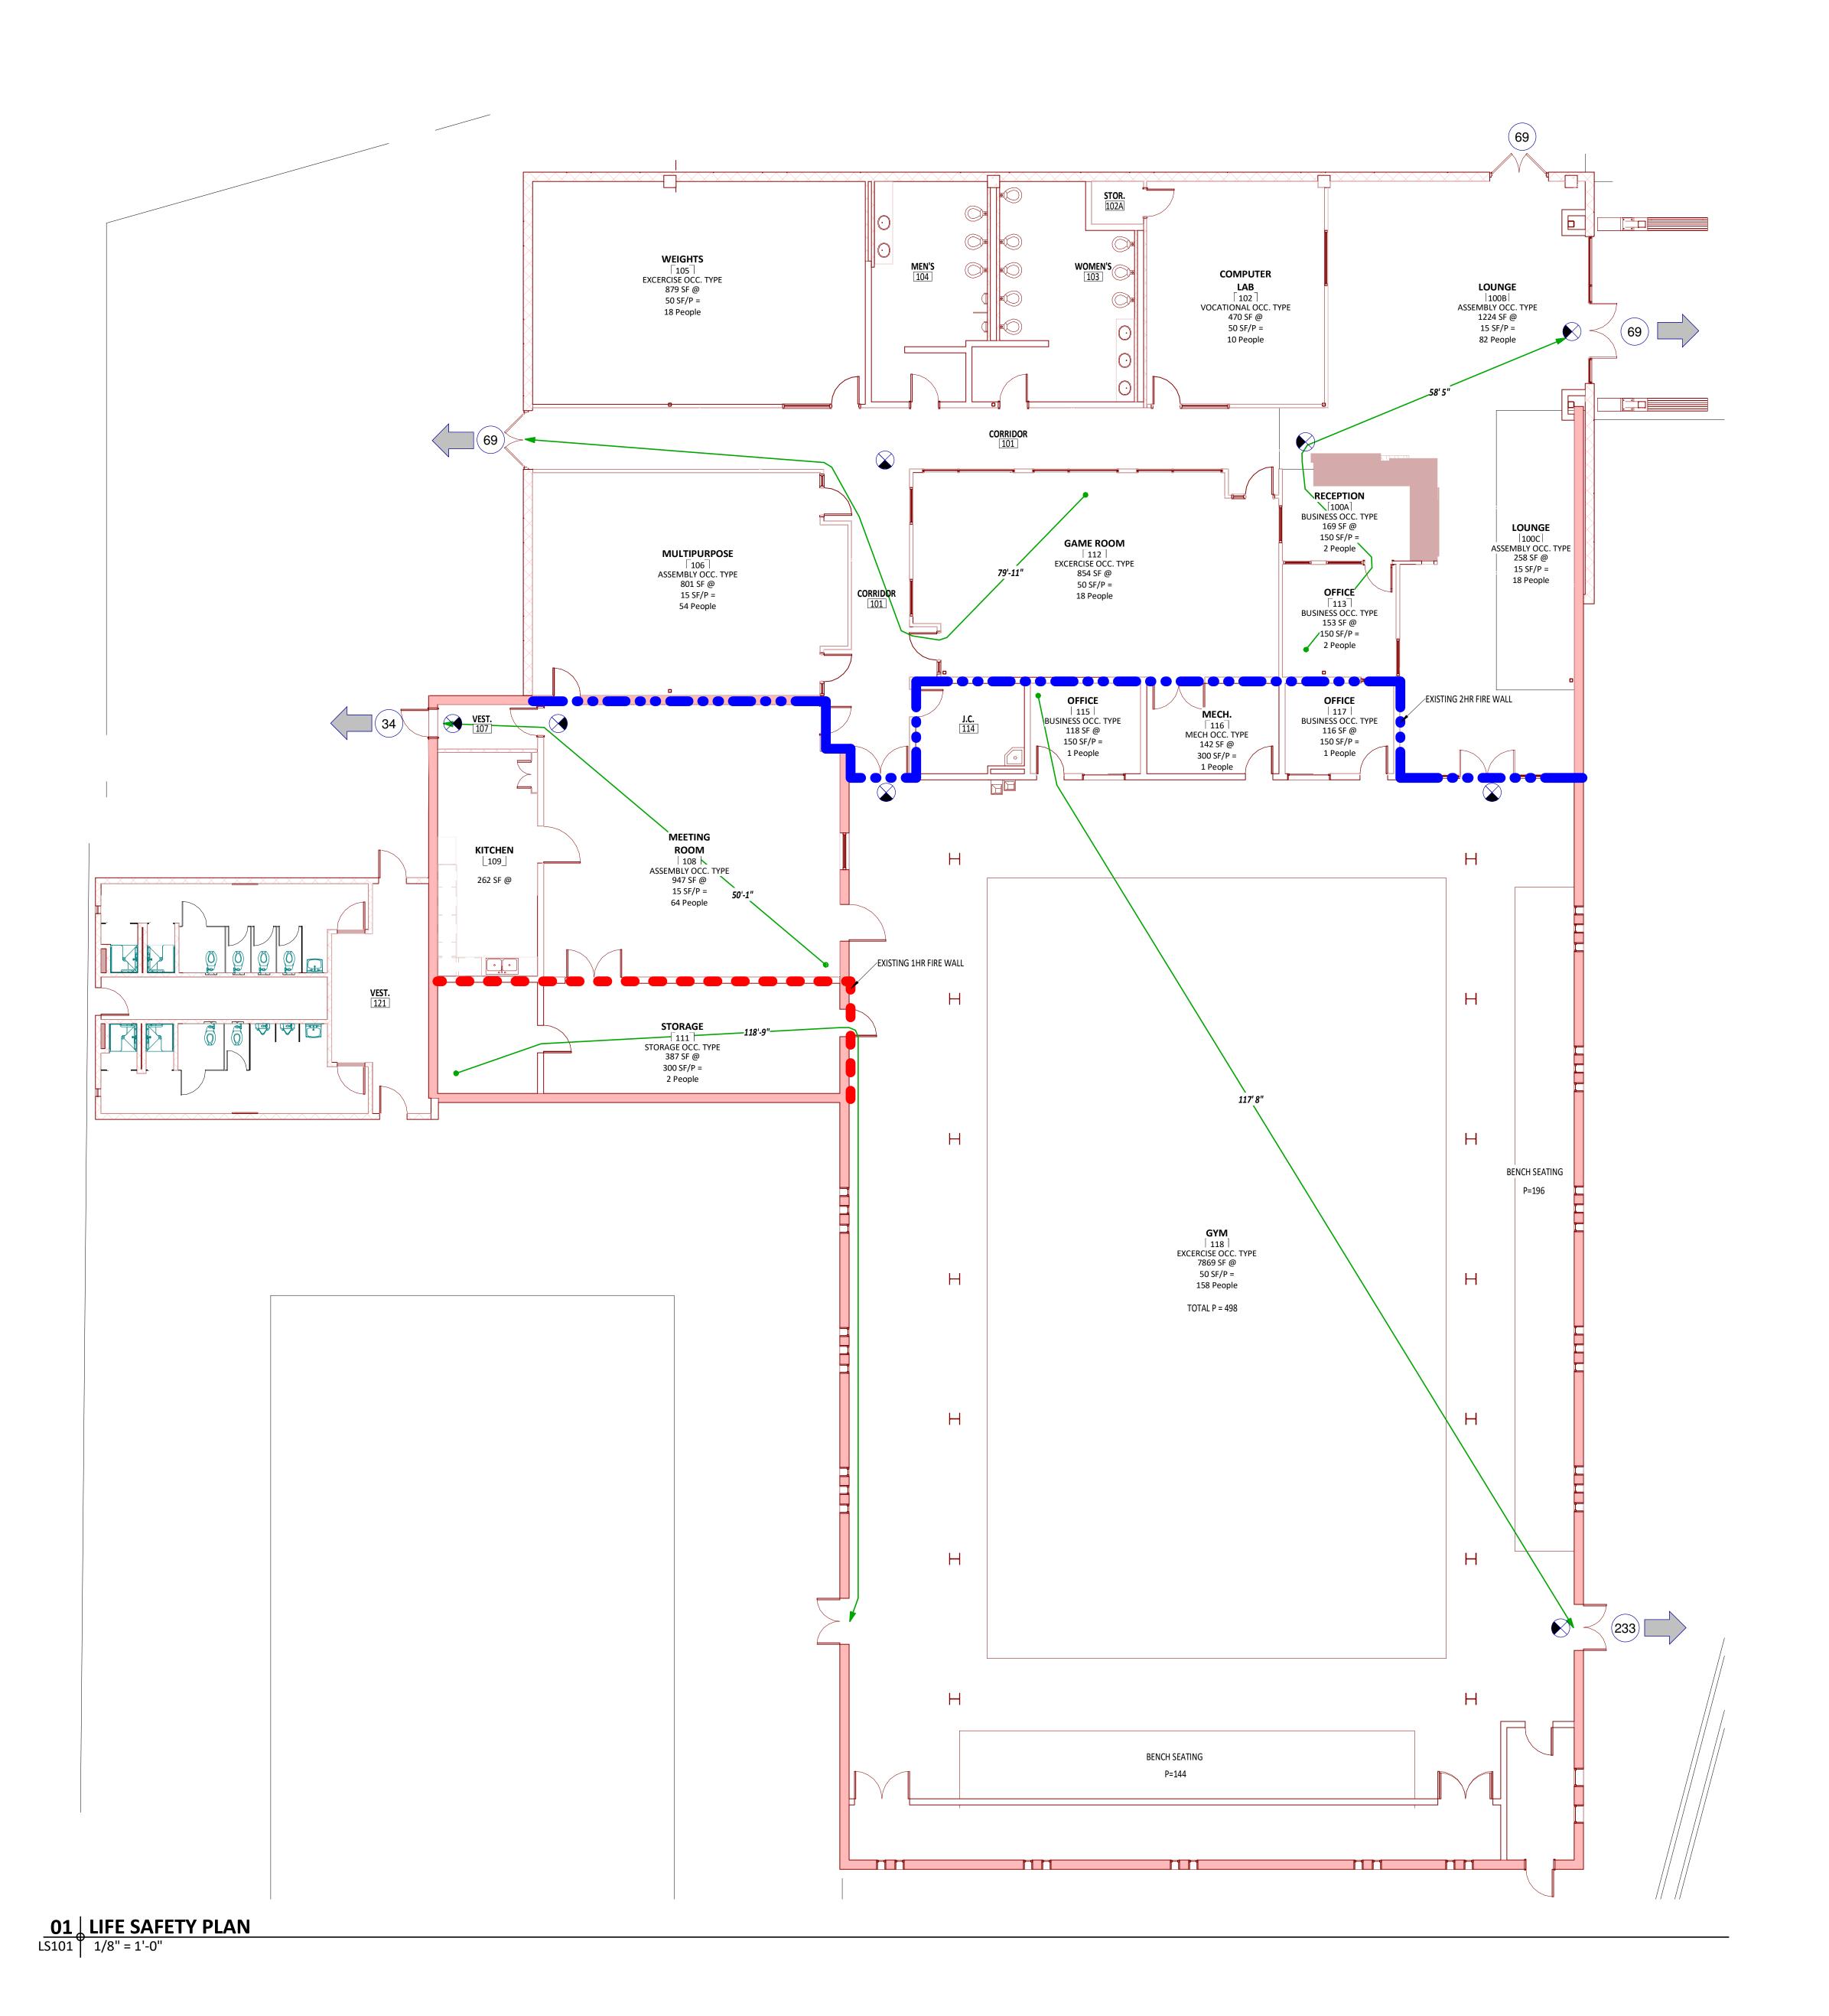

NOTE: LEVEL 1 ALTERATION SCOPE FOR MAIN BUILDING

ALL WORK CONDUCTED WITHIN THE MAIN BUILDING IS CLASSIFIED STRICTLY AS A LEVEL 1 ALTERATION THE SCOPE OF WORK IS LIMITED TO MINOR UPDATES AND REPAIRS AND NO STRUCTURAL MODIFICATIONS AND RECONFIGURATIONS THAT WOULD IMPACT THE EXISTING STRUCTURAL, FIRE PROTECTION, OR EGRESS SYSTEMS.

LIFE SAFETY INFORMATION

BUILDING INFORMATION:
PROJECT NAME: MEMORIAL PARK RECREATION CENTER

ADDRESS: 2465 2ND ST,
MACON, GA 31206
USE: ASSEMBLY
OWNER: MACON-BIBB COUNTY

CODE ANALYSIS :

I. APPLICABLE CODES:
- NFPA 101 - LIFE SAFETY CODE (2018)

- RULES AND REGULATIONS FOR THE STATE MINIMUM FIRE SAFETY; CH. 120-3-20 MODIFICATIONS (2020)
- GEORGIA ACCESSIBILITY CODE FOR BUILDINGS AND FACILITIES; (GAC) - CH. 120-3-20

- INTERNATIONAL FIRE CODE (IFC) (2018), NO GEORGIA AMENDMENTS.
- INTERNATIONAL EXISTING BUILDING CODE (IEBC) (2018), with GEORGIA AMENDMENTS 2021

- INTERNATIONAL BUILDING CODE (IBC) (2018), with GEORGIA AMENDMENTS 2020, 2022.
- INTERNATIONAL MECHANICAL CODE (IBC) (2018), with GEORGIA AMENDMENTS 2020.

- NATIONAL ELECTRICAL CODE, (NEC) (2020), with GEORGIA AMENDMENTS 2021.
- INTERNATIONAL ENERGY CONSERVATION CODE, (IECC) (2015), with GEORGIA SUPPLEMENTS AND AMENDMENTS 2022

II. OCCUPANCY TYPE: - ASSEMBLY (LSC 6.1.2)

III. EXISTING BUILDING CONSTRUCTION TYPE:

- TYPE IIB (IBC TABLE 602.2) - TYPE II(0,0,0) (LSC TABLE A.8.2.1)

IV. BUILDING AREA:
- ALLOWABLE: 3 STORIES @ 38,000 SF (IBC TABLE 506.2)

- ALLOWABLE: 3 STORIES @ 38,000 SF (IBC TABLE - ACTUAL: 1 STORY @ 19,966 SF

V.HOURLY FIRE RATINGS (IBC TABLE 601, LSC TABLE A.8.2.1):

- STRUCTURAL FRAME: 0 HOURS

- BEARING WALLS, EXT.: 2 HOURS

- BEARING WALLS, INT.: 0 HOURS

- NON-BEARING WALLS, EXT.: 0 HOURS

- NON-BEARING WALLS, INT.: 0 HOURS

- ROOF CONSTRUCTION: 0 HOURS

VI. FIRE SUPPRESSION SYSTEM:

- PORTABLE FIRE EXTINGUISHERS -AUTOMATIC SPRINKLER SYSTEM

- FLOOR CONSTRUCTION: 0 HOURS

VII. RENOVATION AREA: ALTERATIONS-LEVEL1

- 1 STORY @ 13,709 GSF TOTAL

VIII. FIRE SAFETY CONCEPT:
- BUILDING IS FULLY SPRINKLERED WITH AN AUTOMATIC SPRINKLER SYSTEM
-EXISTING 1HR AND 2HR FIRE BARRIERS TO REMAIN. SEE LIFE SAFETY PLAN.

IX. OTHER LIFE SAFETY CONSIDERATIONS (MOST STRINGENT OF APPLICABLE CODES GOVERNS):

A.OCCUPANT LOAD: (IBC TABLE 1004.1.1, LSC 7.3.1.2)

ASSEMBLY: 3,230 GSF 15 GSF/OCCUPANT = 219 OCCUPANTS EXERCISE 9,602 GSF

50 GSF/OCCUPANT= 194 OCCUPANTS BENCH SEATING = 340 OCCUPANTS BUSINESS OFFICE: 556 GSF

150 GSF/OCCUPANT = 6 OCCUPANTS

MECH: 142 GSF

300 GSE/OCCUPANT = 1 OCCUPANTS

300 GSF/OCCUPANT = 1 OCCUPANTS

VOCATIONAL: 470 GSF

50 GSF/OCCUPANT = 10 OCCUPANTS

STORAGE: 387 GSF 300 GSF/OCCUPANT = 2 OCCUPANTS

TOTAL = 431 OCCUPANTS

B.EXIT DOOR CAPACITY (IBC TABLE 1005.1, LSC TABLE 7.3.3.1)
- 0.2" EGRESS WIDTH PER OCCUPANT SERVED IN UNSPRINKLERED FACILITY
SEE LIFE SAFETY PLAN FOR REQUIRED AND PROVIDED EGRESS WIDTHS

D. DEAD END (IBC 1017.3) = 20 FEET
 - LSC TABLE A.7.6.1 ALLOWS 50', THEREFORE IBC 20' LIMITATION GOVERNS

E.TRAVEL DISTANCE (IBC TABLE 1016.1) = 200 FEET ALLOWABLE
- LSC TABLE A.7.6.1 ALLOWS 200' FROM ANY POINT IN A ROOM TO EXIT

F. INTERIOR FINISH

1.INTERIOR WALL AND CEILING FINISH (IBC TABLE 803.5, LSC 38.3.3.2)
INTERIOR WALL AND CEILING FINISH COMPLYING WITH 10.2.3 SHALL BE AT
A MINIMUM REQUIREMENT CLASS A IN EXIT ENCLOSURES AND
PASSAGEWAYS, CLASS B IN CORRIDORS, AND CLASS C IN OFFICE AREAS.

2. INTERIOR FLOOR FINISH (IBC 804.4.1) - CLASS II

MAXIMUM ACTUAL EXIT DISTANCE = 117' 8"







MACON-BIBB COUNTY PARKS AND RECREATION

MEMORIAL PARK RECREATION CENTER RENOVATION 2465 2ND ST, MACON, GA 31206

These drawings convey certain contractual information through the use of color. Do NOT use drawings printed in black-and-white or greyscale.

d/b/a WM2A Architects.
These drawings, as instruments of service, remain the property of the Architect.
Unauthorized use or reproduction is forbidden.

© 2023, WMA Architects/Planners, Inc.

Revision No (if any): Revision Date:


Project No: Current Date:

2024-079 10/30/24

LIFE SAFETY PLAN

LS101

Issued for Permit

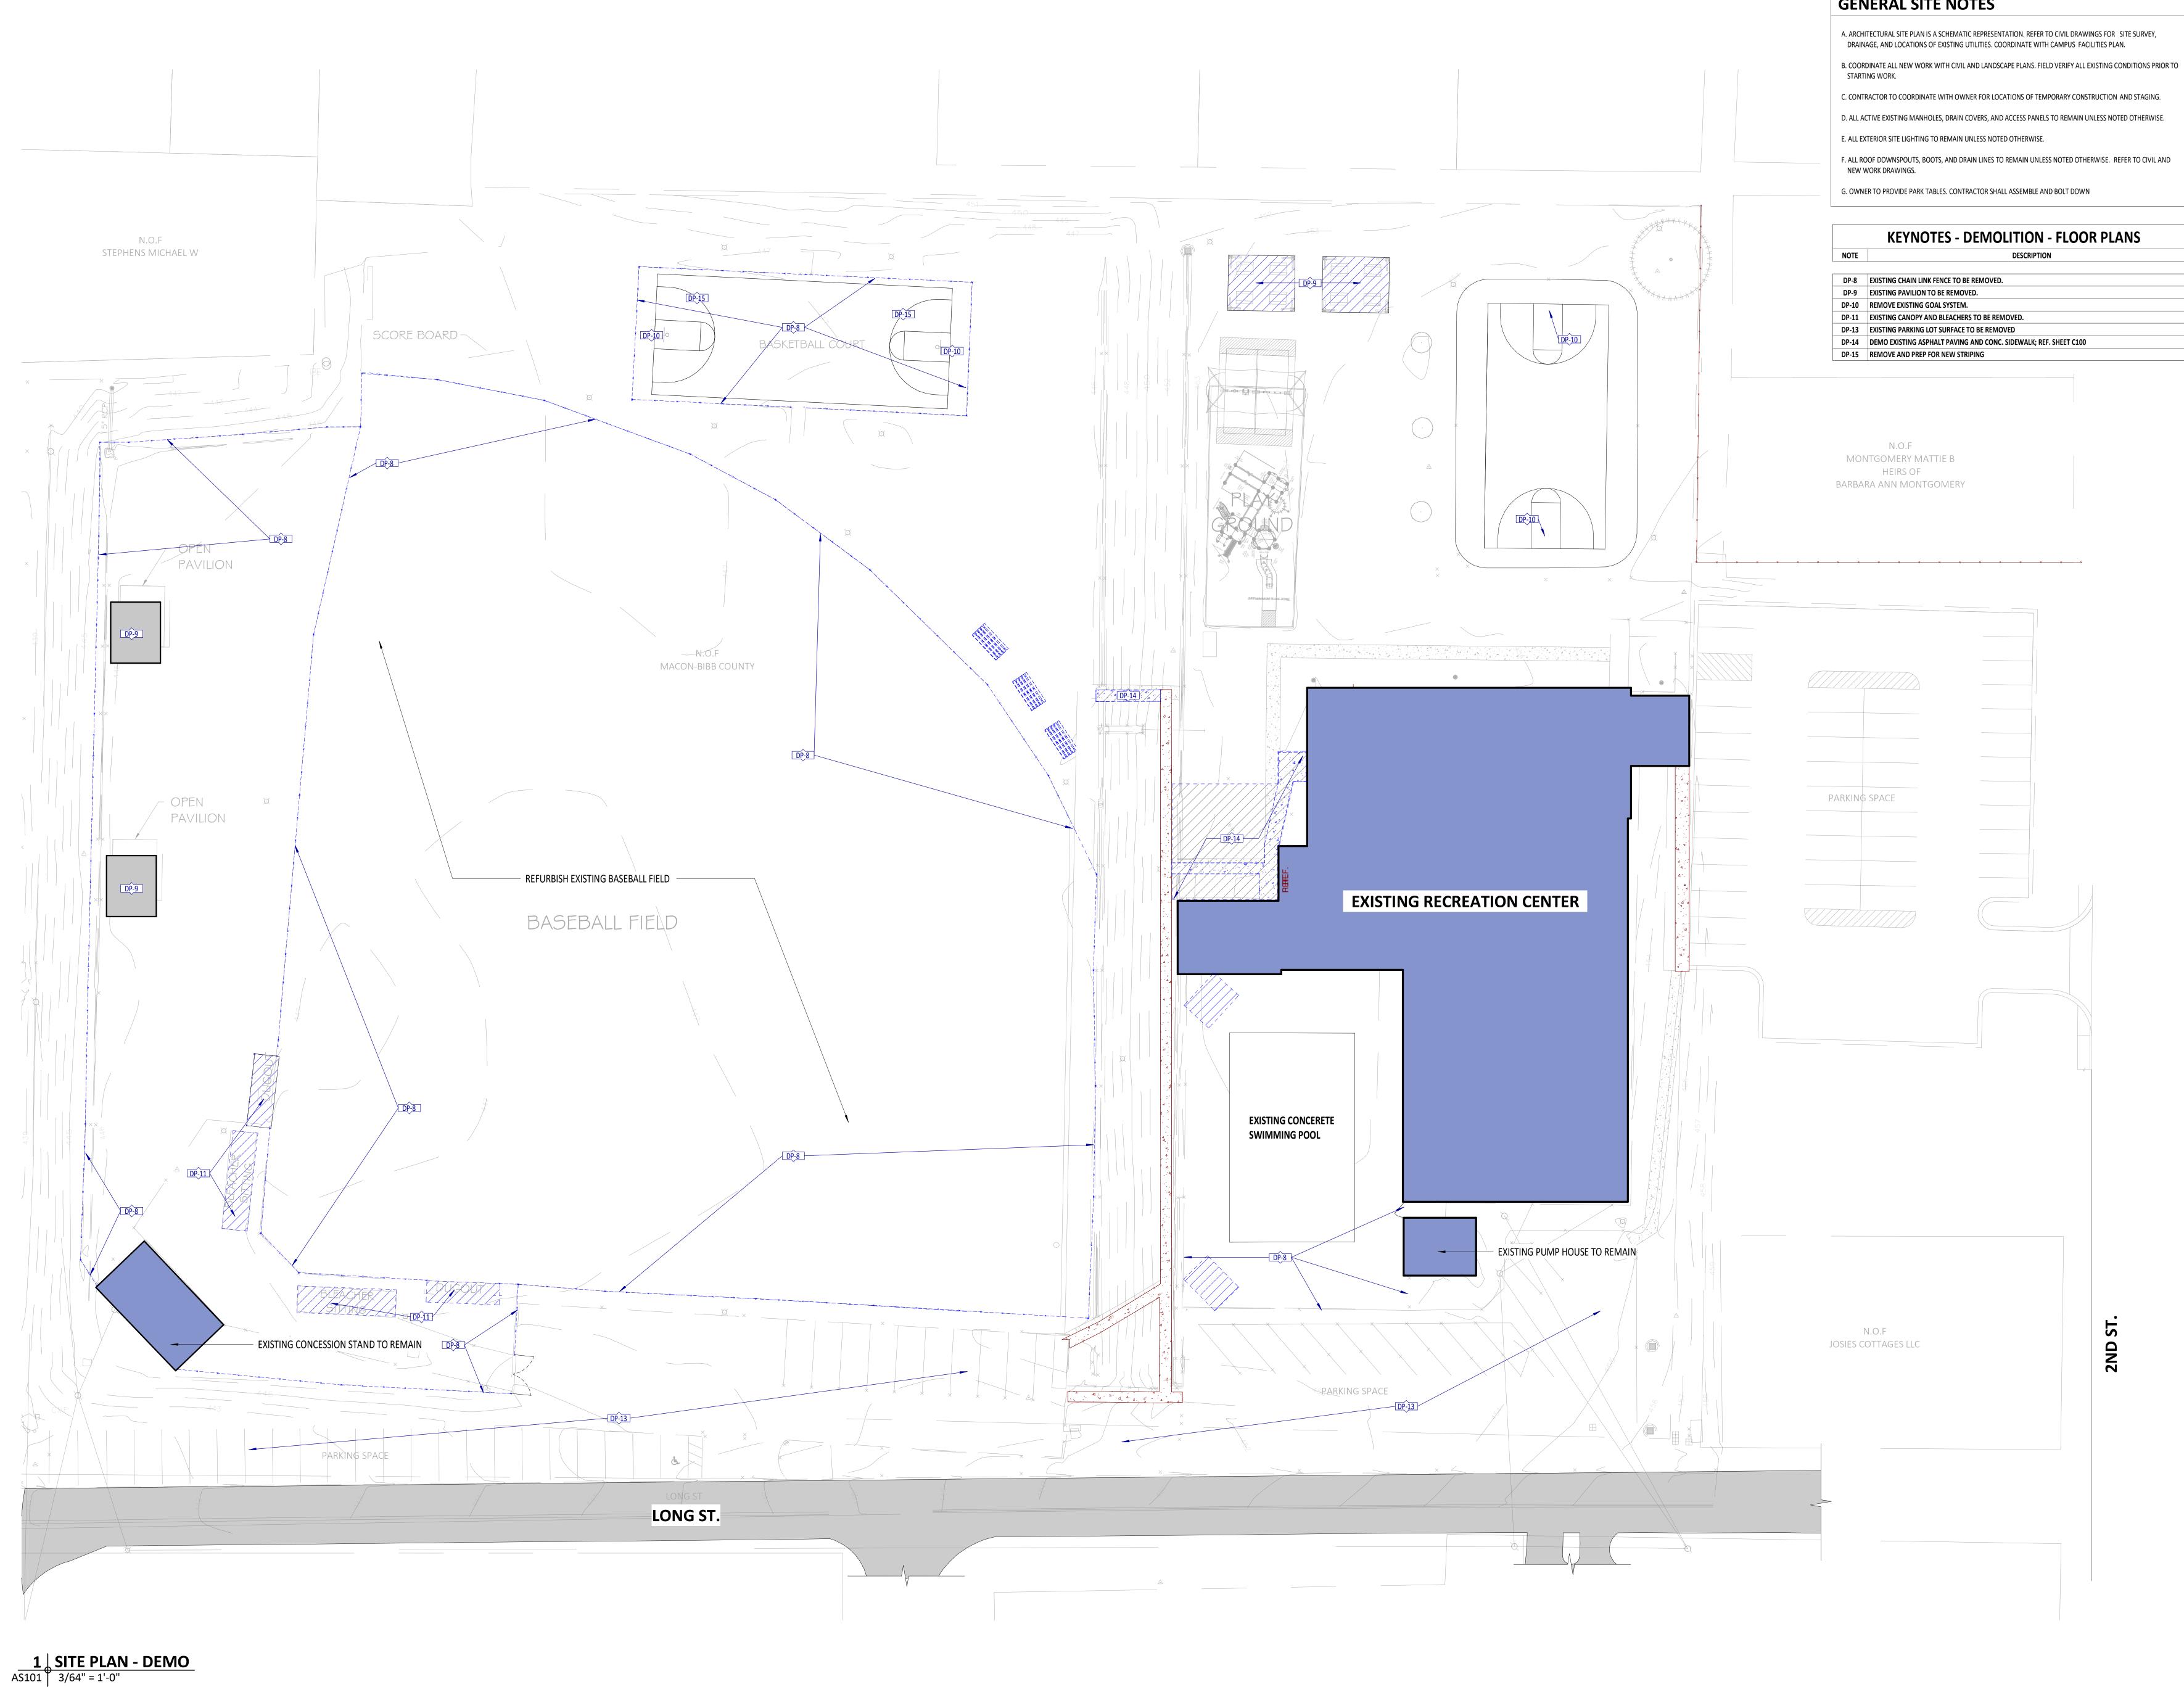

GENERAL SITE NOTES

C. CONTRACTOR TO COORDINATE WITH OWNER FOR LOCATIONS OF TEMPORARY CONSTRUCTION AND STAGING.



MACON, GEORGIA 31201

MACON-BIBB COUNTY PARKS AND RECREATION

MEMORIAL PARK RECREATION **CENTER RENOVATION**

2465 2ND ST, MACON, GA 31206

These drawings convey certain contractual information through the use of color. Do NOT use drawings printed in black-and-white or greyscale.


© 2023, WMA Architects/Planners, Inc. d/b/a WM2A Architects. These drawings, as instruments of service, remain the property of the Architect.
Unauthorized use or reproduction is forbidden.

Project No: Current Date: 2024-079 10/30/24

Drawing Name:

ARCHITECTURAL SITE PLAN -

AS101

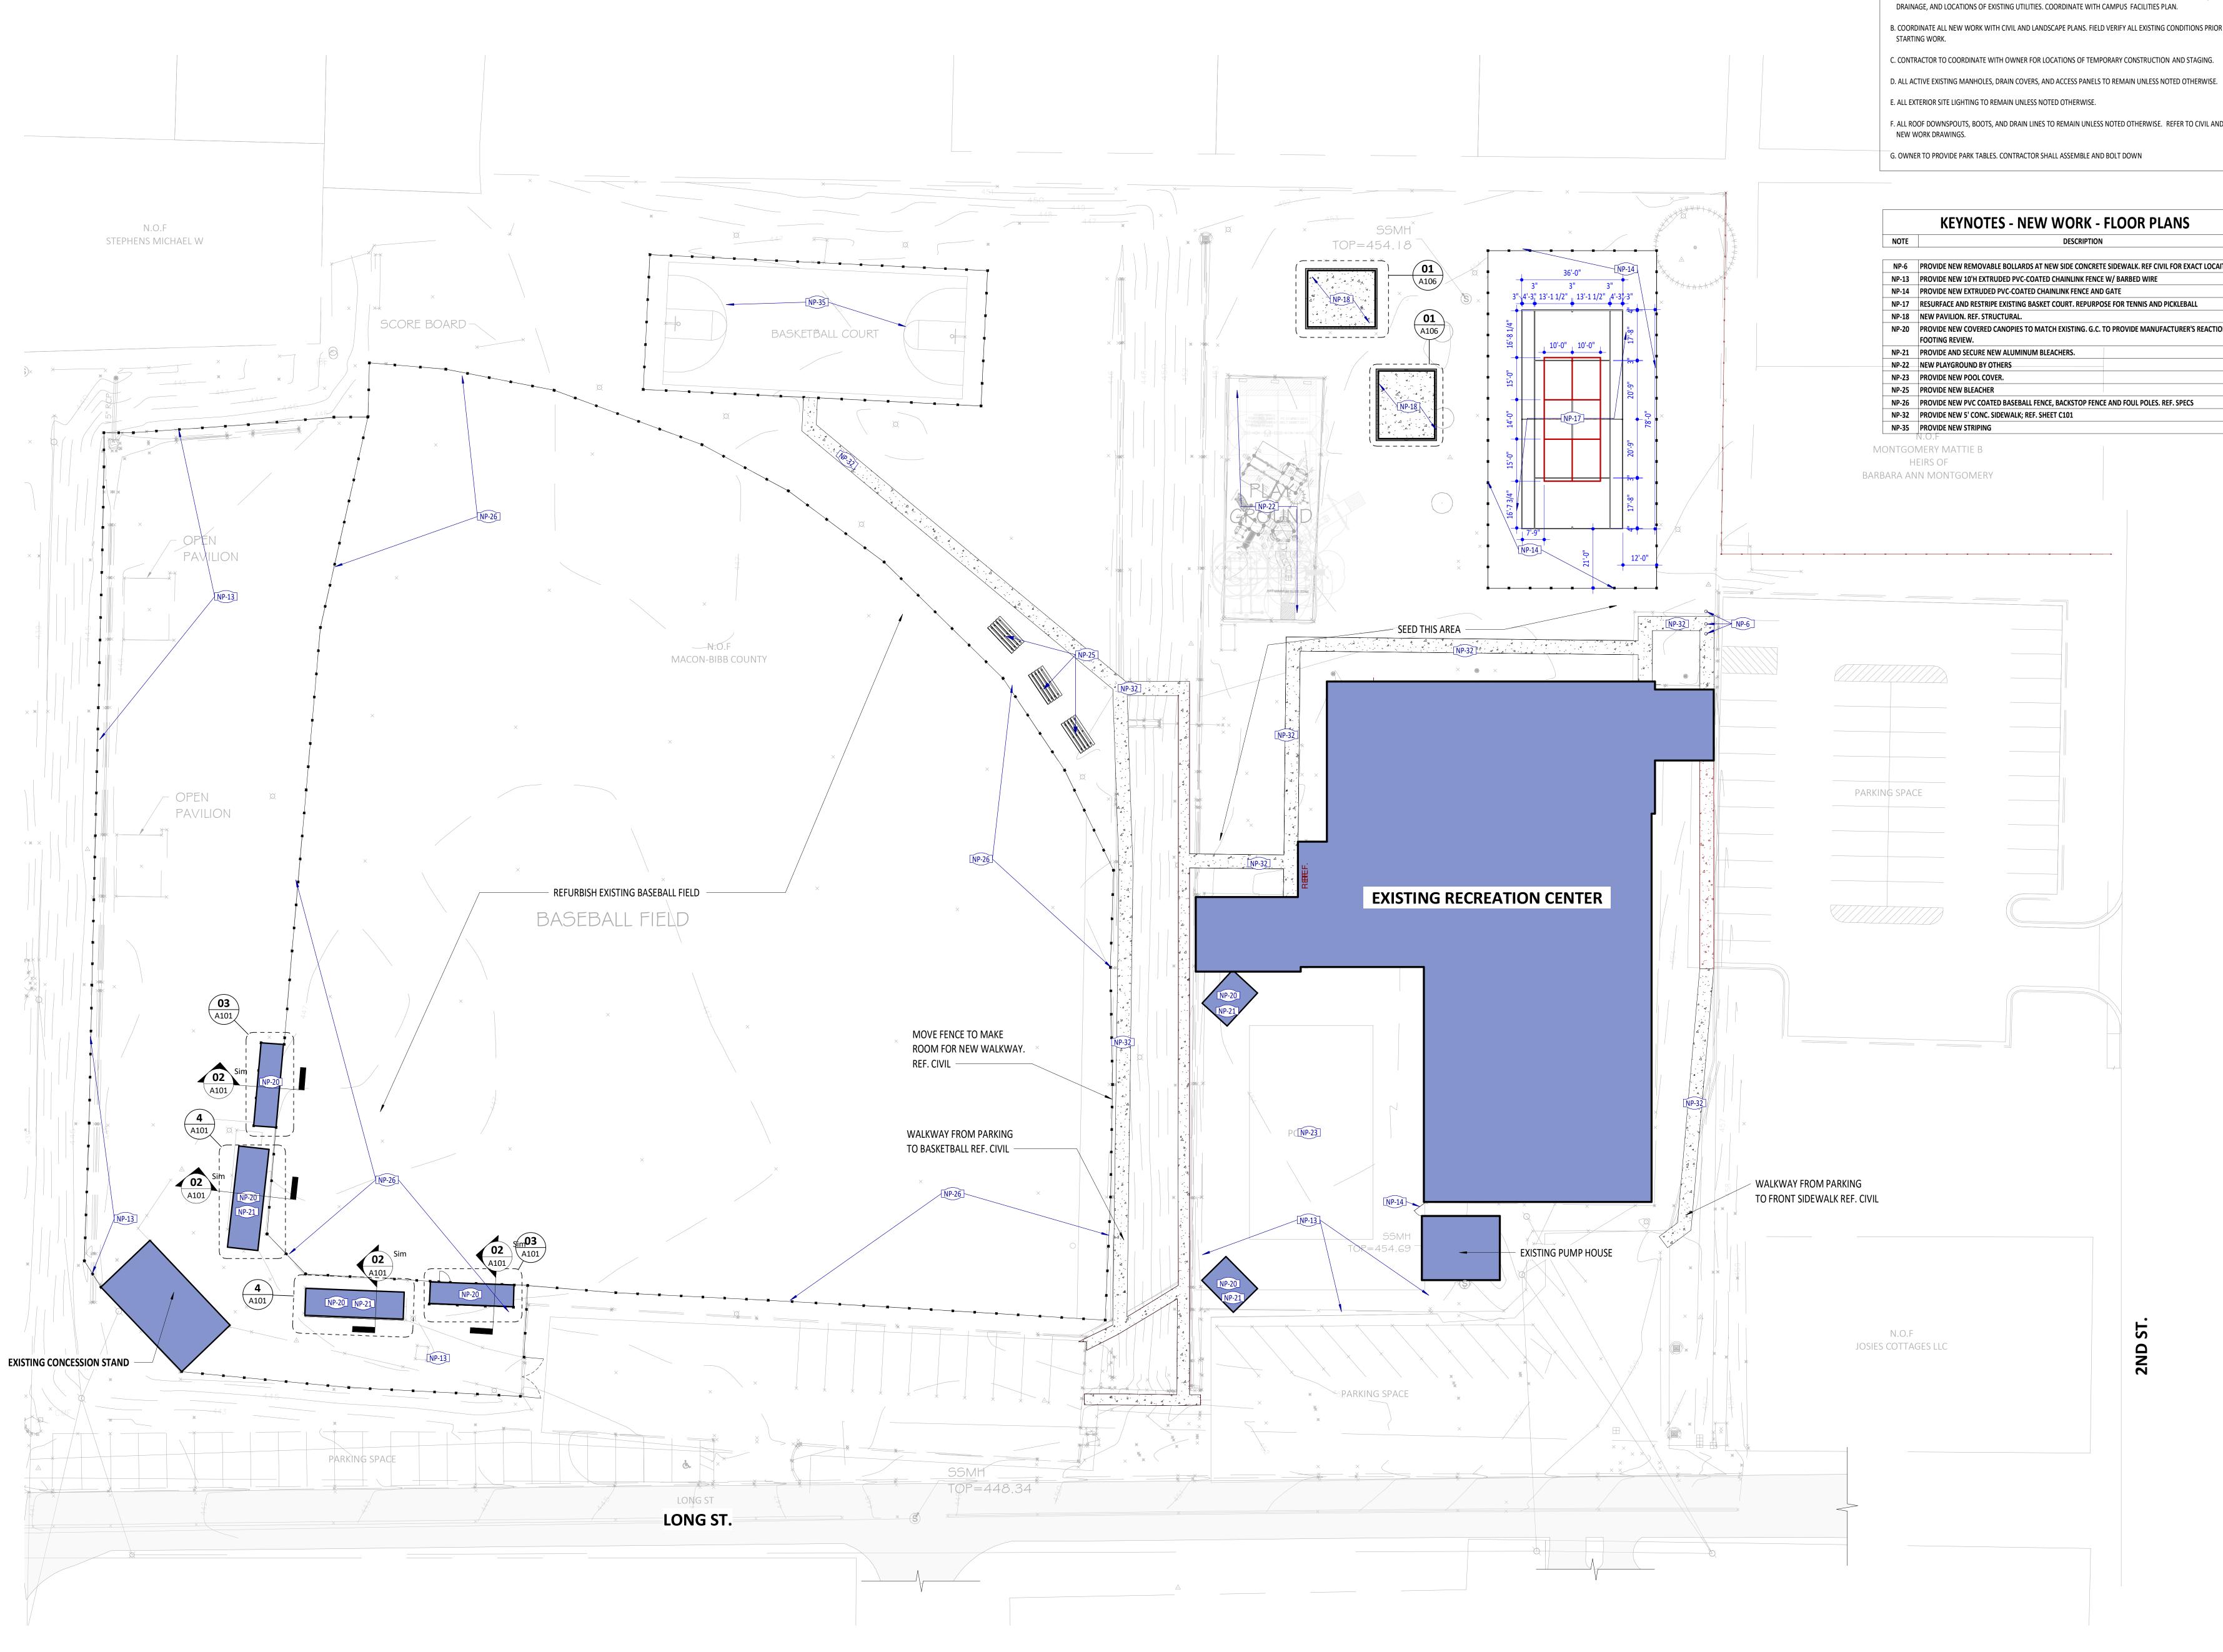

AS102 3/64" = 1'-0"



A. ARCHITECTURAL SITE PLAN IS A SCHEMATIC REPRESENTATION. REFER TO CIVIL DRAWINGS FOR SITE SURVEY, DRAINAGE, AND LOCATIONS OF EXISTING UTILITIES. COORDINATE WITH CAMPUS FACILITIES PLAN.

B. COORDINATE ALL NEW WORK WITH CIVIL AND LANDSCAPE PLANS. FIELD VERIFY ALL EXISTING CONDITIONS PRIOR TO

F. ALL ROOF DOWNSPOUTS, BOOTS, AND DRAIN LINES TO REMAIN UNLESS NOTED OTHERWISE. REFER TO CIVIL AND



NP-6 PROVIDE NEW REMOVABLE BOLLARDS AT NEW SIDE CONCRETE SIDEWALK. REF CIVIL FOR EXACT LOCAITON.

NP-20 PROVIDE NEW COVERED CANOPIES TO MATCH EXISTING. G.C. TO PROVIDE MANUFACTURER'S REACTIONS FOR

MACON, GEORGIA 31201

BRANDON A

MACON-BIBB COUNTY PARKS AND RECREATION

MEMORIAL PARK RECREATION **CENTER RENOVATION** 2465 2ND ST, MACON, GA 31206

information through the use of color. Do NOT use drawings printed in black-and-white or greyscale. © 2023, WMA Architects/Planners, Inc.

These drawings convey certain contractual

d/b/a WM2A Architects. These drawings, as instruments of service, remain the property of the Architect.
Unauthorized use or reproduction is forbidden.

Project No: Current Date:

2024-079 10/30/24

Drawing Name:

ARCHITECTURAL SITE PLAN -


AS102



KEYNOTES - NEW WORK - FLOOR PLANS DESCRIPTION NP-5 PROVIDE ALLOWANCE IN COST ESTIMATE TO REPLACE +/- 60 SQ FT OF DAMAGED FLOORING, ROOF MEMBERS, ROOF MEMBRANE, ROOF DRAINS AND SCUPPER . G.C. TO INVESTIGATE SOURCE AND EXTENTS OF WATER LEAK AND DAMEAGE IN THIS AREA. REPORT FINDINGS TO ARCHITECT NP-6 PROVIDE NEW REMOVABLE BOLLARDS AT NEW SIDE CONCRETE SIDEWALK. REF CIVIL FOR EXACT NP-8 REPAIR DAMAGED DRYWALL AND PROVIDE NEW DOOR STOP. NP-10 PREP AND PAINT ALL GYMNASIUM WALLS AND COLUMNS. REF. FINISH PLAN AND SCHEDULES. NP-11 REPAINT ALL EXISTING FIBER CEMENT PANELS AND REPLACE ALL DAMAGED PANELS. REF. SHEET A201 NP-21 PROVIDE AND SECURE NEW ALUMINUM BLEACHERS. NP-23 PROVIDE NEW POOL COVER. NP-27 PROVIDE NEW CLEAR LEXAN CORNER GUARD NP-28 CLEAN AND REPAINT HOLLOW METAL WINDOW FRAME NP-29 REMOVE AND REPLACE EXISTING WALL MATS. COLOR TO MATCH EXISTING NP-36 PROVIDE AND SECURE NEW METAL BENCH.





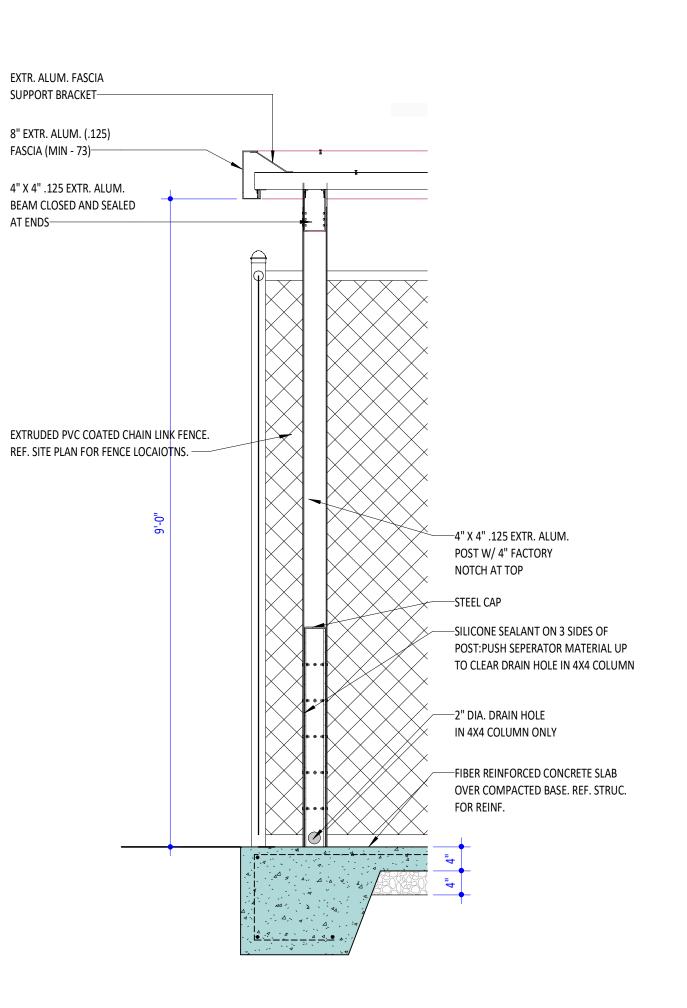





MACON-BIBB COUNTY PARKS AND RECREATION

MEMORIAL PARK RECREATION **CENTER RENOVATION** 2465 2ND ST, MACON, GA 31206

02 | CANOPY SECTION A101 | 3/4" = 1'-0"

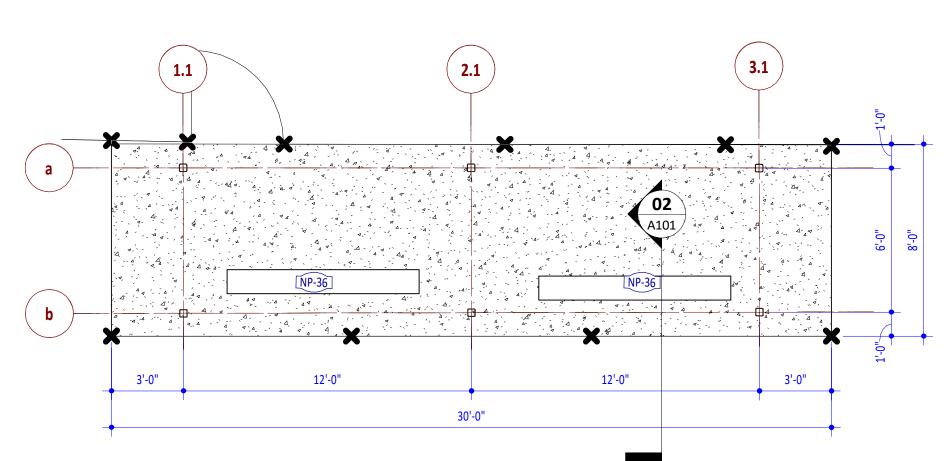

03 DUGOUT PLAN
A101 1/4" = 1'-0"

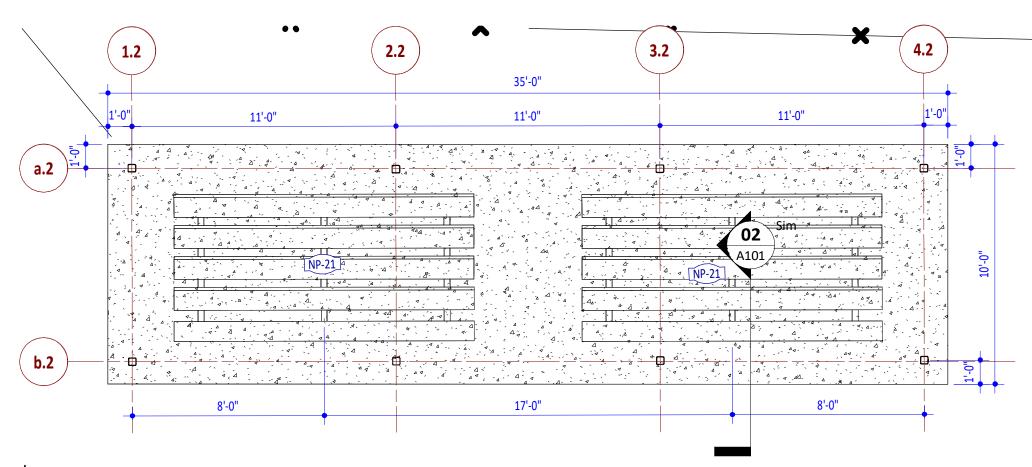


A101 1/4" = 1'-0"


These drawings convey certain contractual information through the use of color. Do NOT use drawings printed in black-and-white or greyscale. © 2023, WMA Architects/Planners, Inc. d/b/a WM2A Architects. These drawings, as instruments of service, remain the property of the Architect. Unauthorized use or reproduction is forbidden. Issued for Permit

2024-079 10/30/24


Project No: Current Date:

OVERALL FLOOR PLAN A101

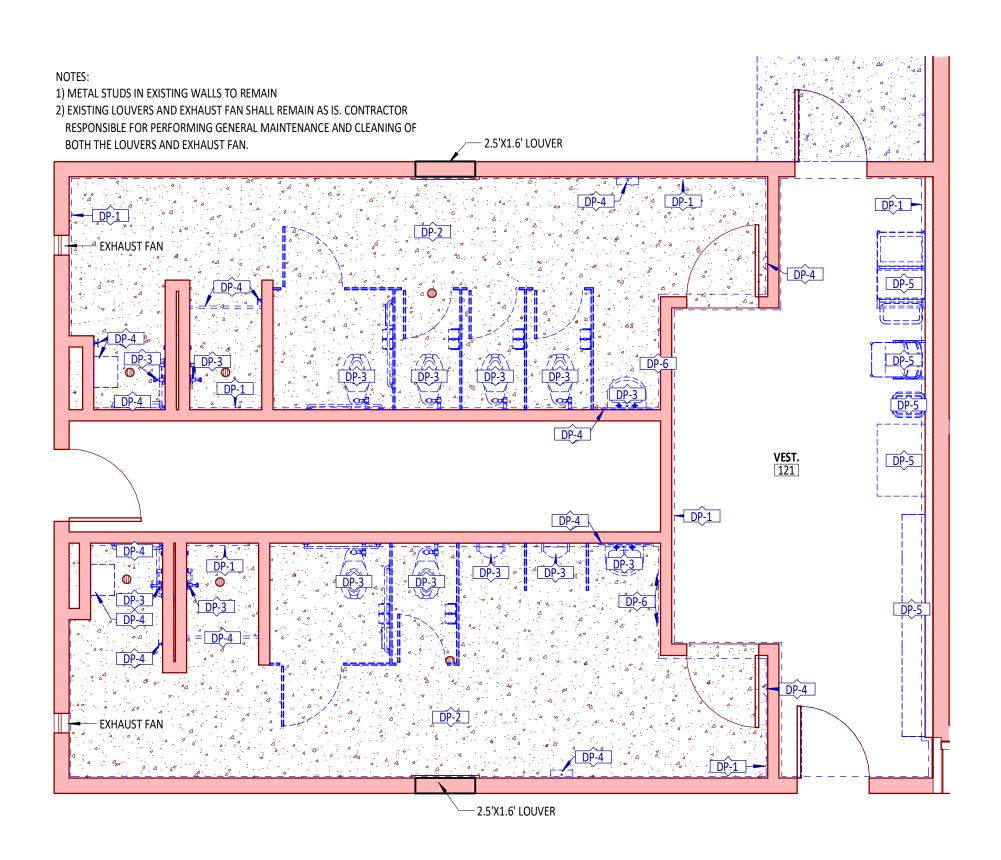


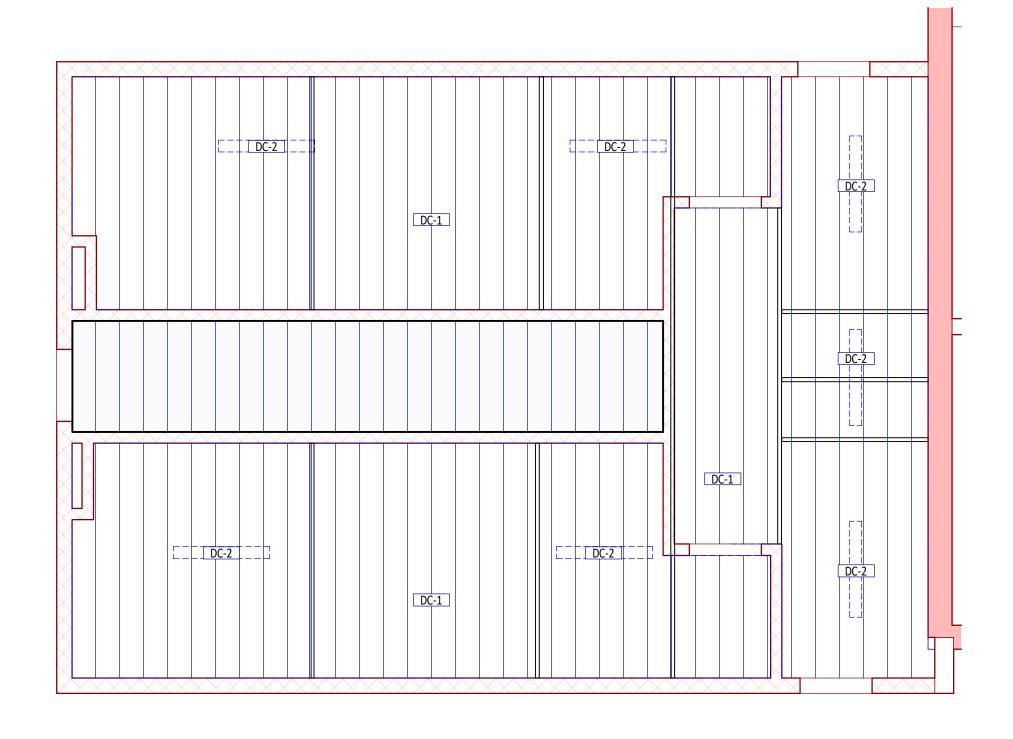

O1 RESTROOMS FLOOR PLAN - DEMOLITION A102 1/4" = 1'-0"

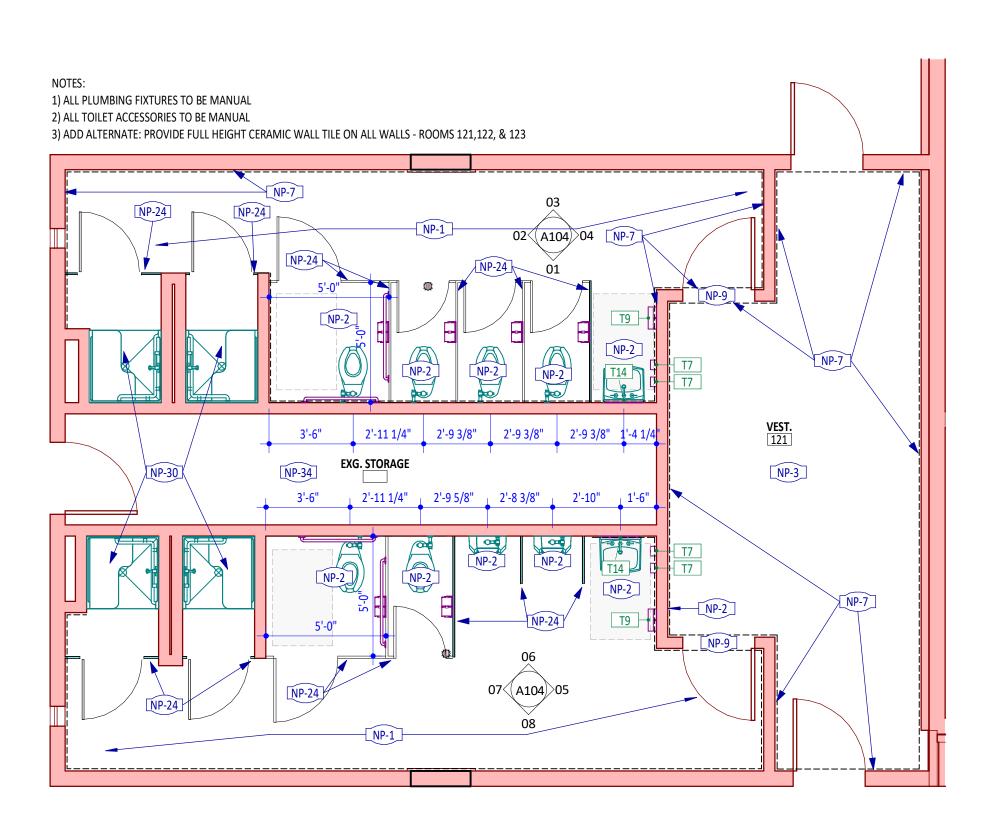

O2 RESTROOM RCP - DEMOLITION PLAN
A102 1/4" = 1'-0"

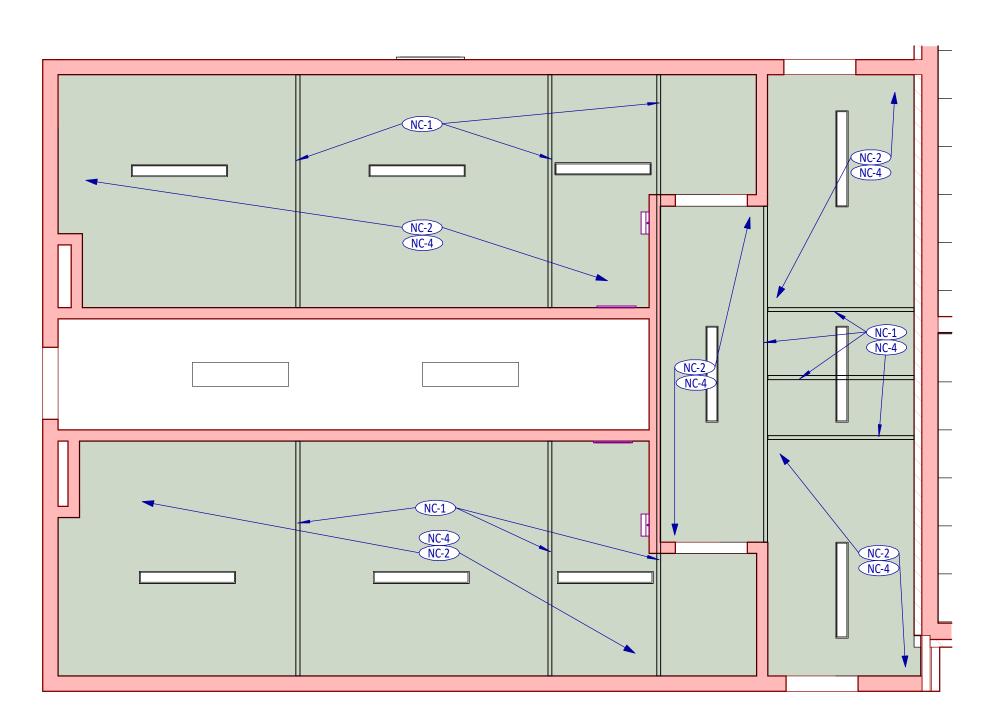

03 | RESTROOMS FLOOR PLAN - NEW WORK

A102 | 1/4" = 1'-0"

04 | RESTROOM RCP - NEW WORK PLAN

A102 | 1/4" = 1'-0"

KEYNOTES - DEMOLITION - FLOOR PLANS

DESCRIPTION

DP-1 EXISTING WALL FINISH TO BE REMOVED

DP-2 EXISTING FLOORING TO BE DEMOLISHED DP-3 PLUMBING FIXTURE TO BE DEMOLISHED

DP-4 TOILET ACCESSORY TO BE REMOVED DP-5 SHOW REMOVAL BY OWNER FOR DURATION OF WORK

DP-6 SURFACE-MOUNTED CONDUIT TO BE REMOVED

KEYNOTES - NEW WORK - FLOOR PLANS

DESCRIPTION

NP-1 PROVIDE NEW EPOXY FLOOR FINISH. REF. FINISH PLAN FOR COLOR.

NOTE

NOTE

NP-2 PROVIDE NEW EMERGENCY PHONE. REF. ELECT.

NP-3 CLEAN EXISTING EPOXY FLOOR.

NP-7 PROVIDE NEW FIBER REINFORCED PLASTIC PANELS. NP-9 PREP AND REPAINT DOOR FRAME AND PANEL. REF FINISH LEGEND FOR COLOR

NP-24 PROVIDE NEW SOLID PHENOLIC TOILET PARTITIONS. COLOR TO BE CHOSEN BY OWNER

NP-30 PROVIDE NEW FIBERGLASS SHOWER INSERT NP-34 PROVIDE NEW LIGHT FIXTURES. REF. ELEC.

KEYNOTES - NEW WORK - CEILINGS

DESCRIPTION

NC-1 EXISTING BEAMS TO BE REPAINTED AND LEFT EXPOSED. COLOR: P-6 NC-2 PROVIDE NEW GYPBOARD CEILING. MATCH EXISTING CEILING HEIGHT.

NC-4 PROVIDE NEW LIGHT FIXTURES. REF. ELEC.

KEYNOTES - DEMOLITION - CEILING

DESCRIPTION

DC-1 DEMOLISH EXISTING CEILING

DC-2 DEMOLISH EXISTING CEILING LIGHT

Moisture Resistent Gyp LIGHTING - SURFACE MOUNTED FIXTURE

Paint P-6

Reflected ceiling plan(s) on architectural drawings often do NOT indicate all ceiling-

mounted items. See drawings of other disciplines for additional items. Coordinate installation of all required ceiling items.


Color shades used on reflected ceiling plans and legends are provided to help the Contractor identify types of ceilings. These shades do NOT indicate finish colors.

LEGEND - REFLECTED CEILING PLAN

1/8" = 1'-0"

SUITE 500, PO BOX 110 MACON, GEORGIA 31201



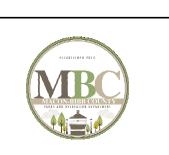

MACON-BIBB COUNTY PARKS AND RECREATION

MEMORIAL PARK RECREATION **CENTER RENOVATION**

2465 2ND ST, MACON, GA 31206

These drawings convey certain contractual information through the use of color. Do NOT use drawings printed in black-and-white or greyscale.

© 2023, WMA Architects/Planners, Inc. d/b/a WM2A Architects. These drawings, as instruments of service, remain the property of the Architect. Unauthorized use or reproduction is forbidden.


Project No: Current Date:

2024-079 10/30/24

Drawing Name:


RESTROOM - FLOOR PLANS


Drawing No:

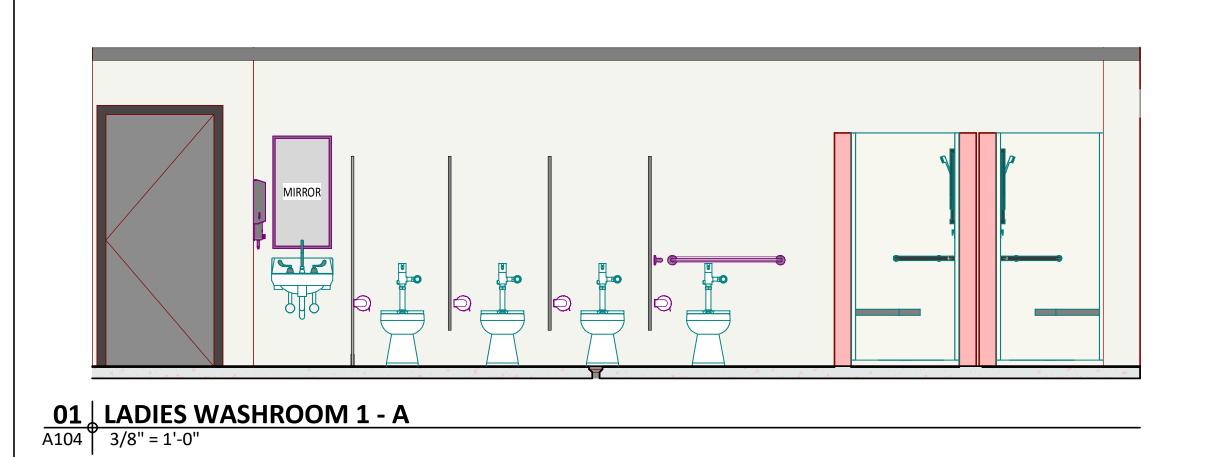




TOILET ACCESSORIES BY ROOM								
ROOM NO.	ROOM NAME	TYPE MARK	DESCRIPTION	COUNT	0,0 / 0,0 / 0,0			
		Т3	36" Grab Bar					
				2	C,C			
		T4	42" Grab Bar	2	C,C			
		T7	Soap Dispenser	4	C,C			
			· ·					
		Т9	Paper Towel Dispenser, surface-mounted.	2	C,C			
		T9 T10		6	c,c c,c			

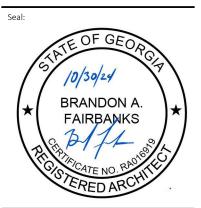


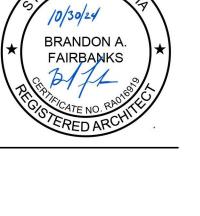

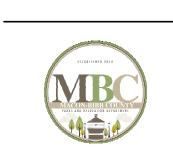



MEMORIAL PARK RECREATION **CENTER RENOVATION**




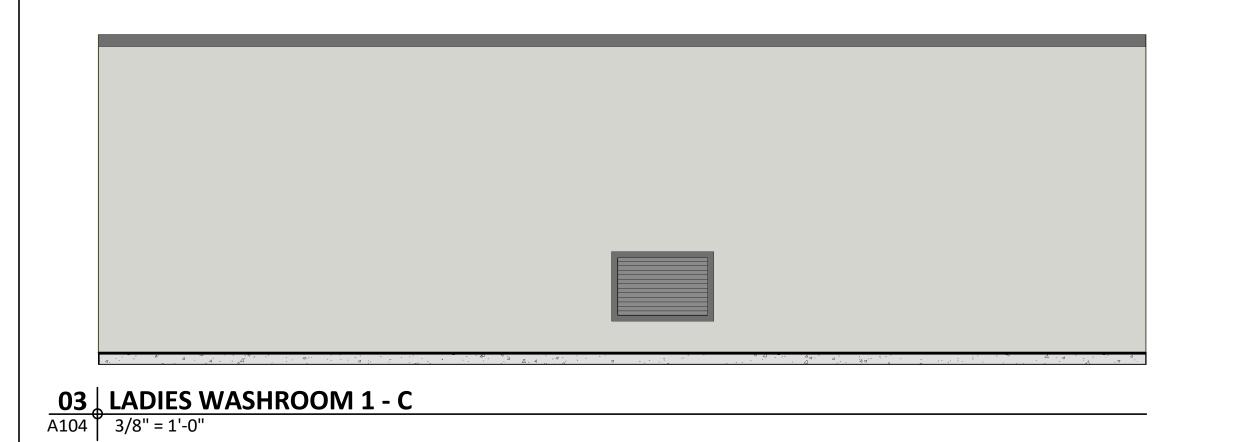



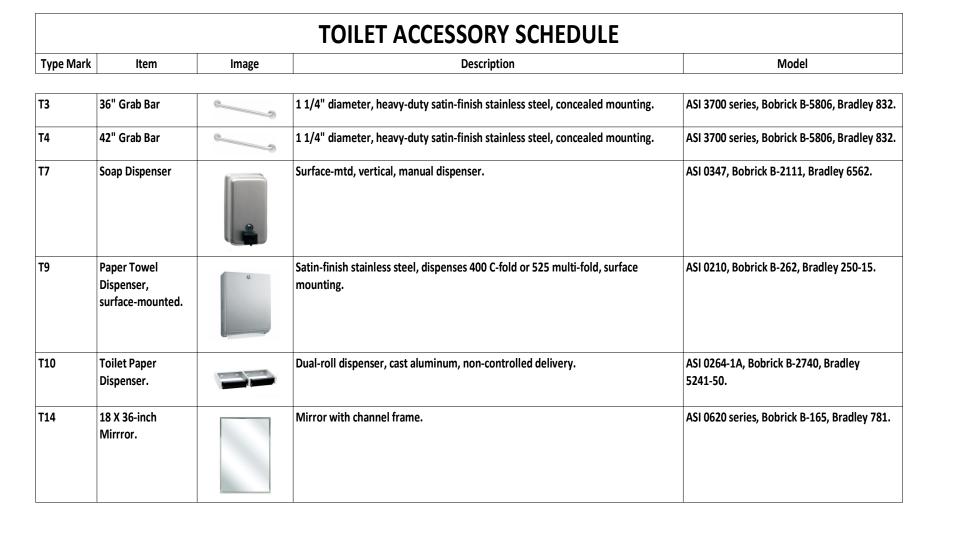


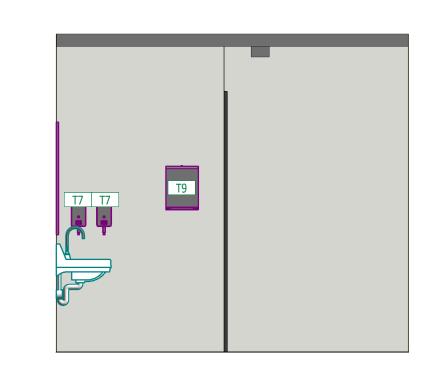


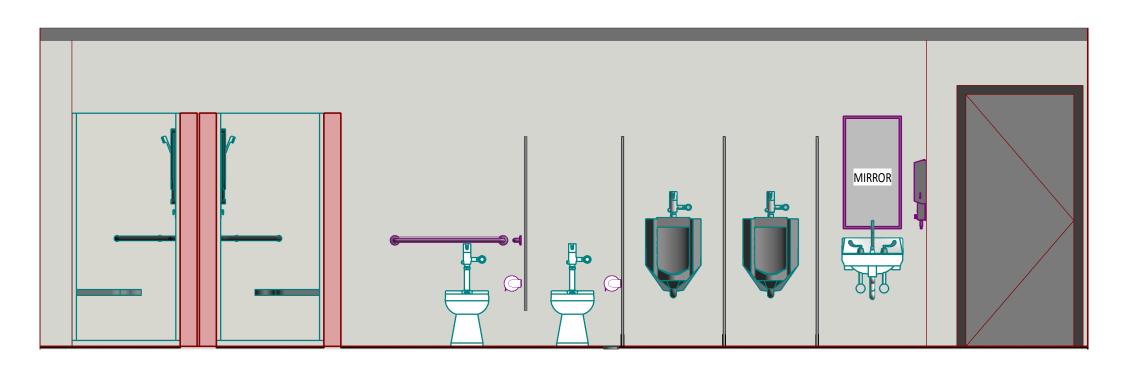



06 GENTS WASHROOM 1 - B
A104 3/8" = 1'-0"

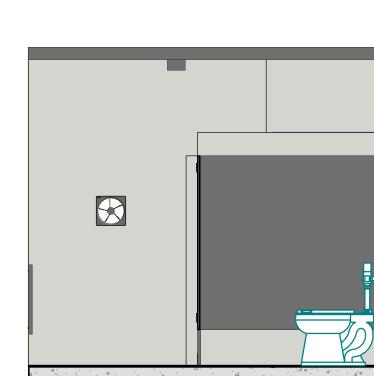

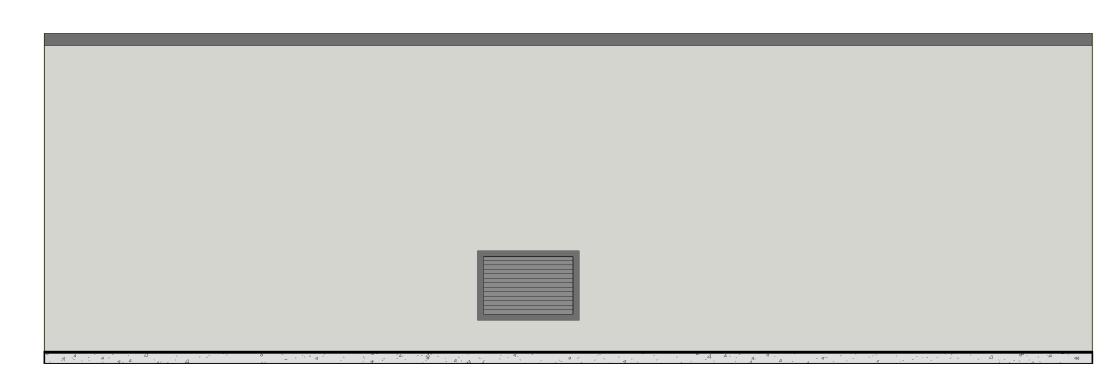

07 | GENTS WASHROOM 1 - C A104 | 3/8" = 1'-0"

08 GENTS WASHROOM 1 - D
A104 3/8" = 1'-0"

These drawings convey certain contractual information through the use of color. Do NOT use drawings printed in black-and-white or greyscale.

© 2023, WMA Architects/Planners, Inc. d/b/a WM2A Architects.

These drawings, as instruments of service, remain the property of the Architect.

Unauthorized use or reproduction is forbidden. Project Status:


Project No: Current Date: 2024-079 10/30/24

Drawing Name:

Revision No (if any): Revision Date:

RESTROOM - ELEVATIONS

Drawing No:

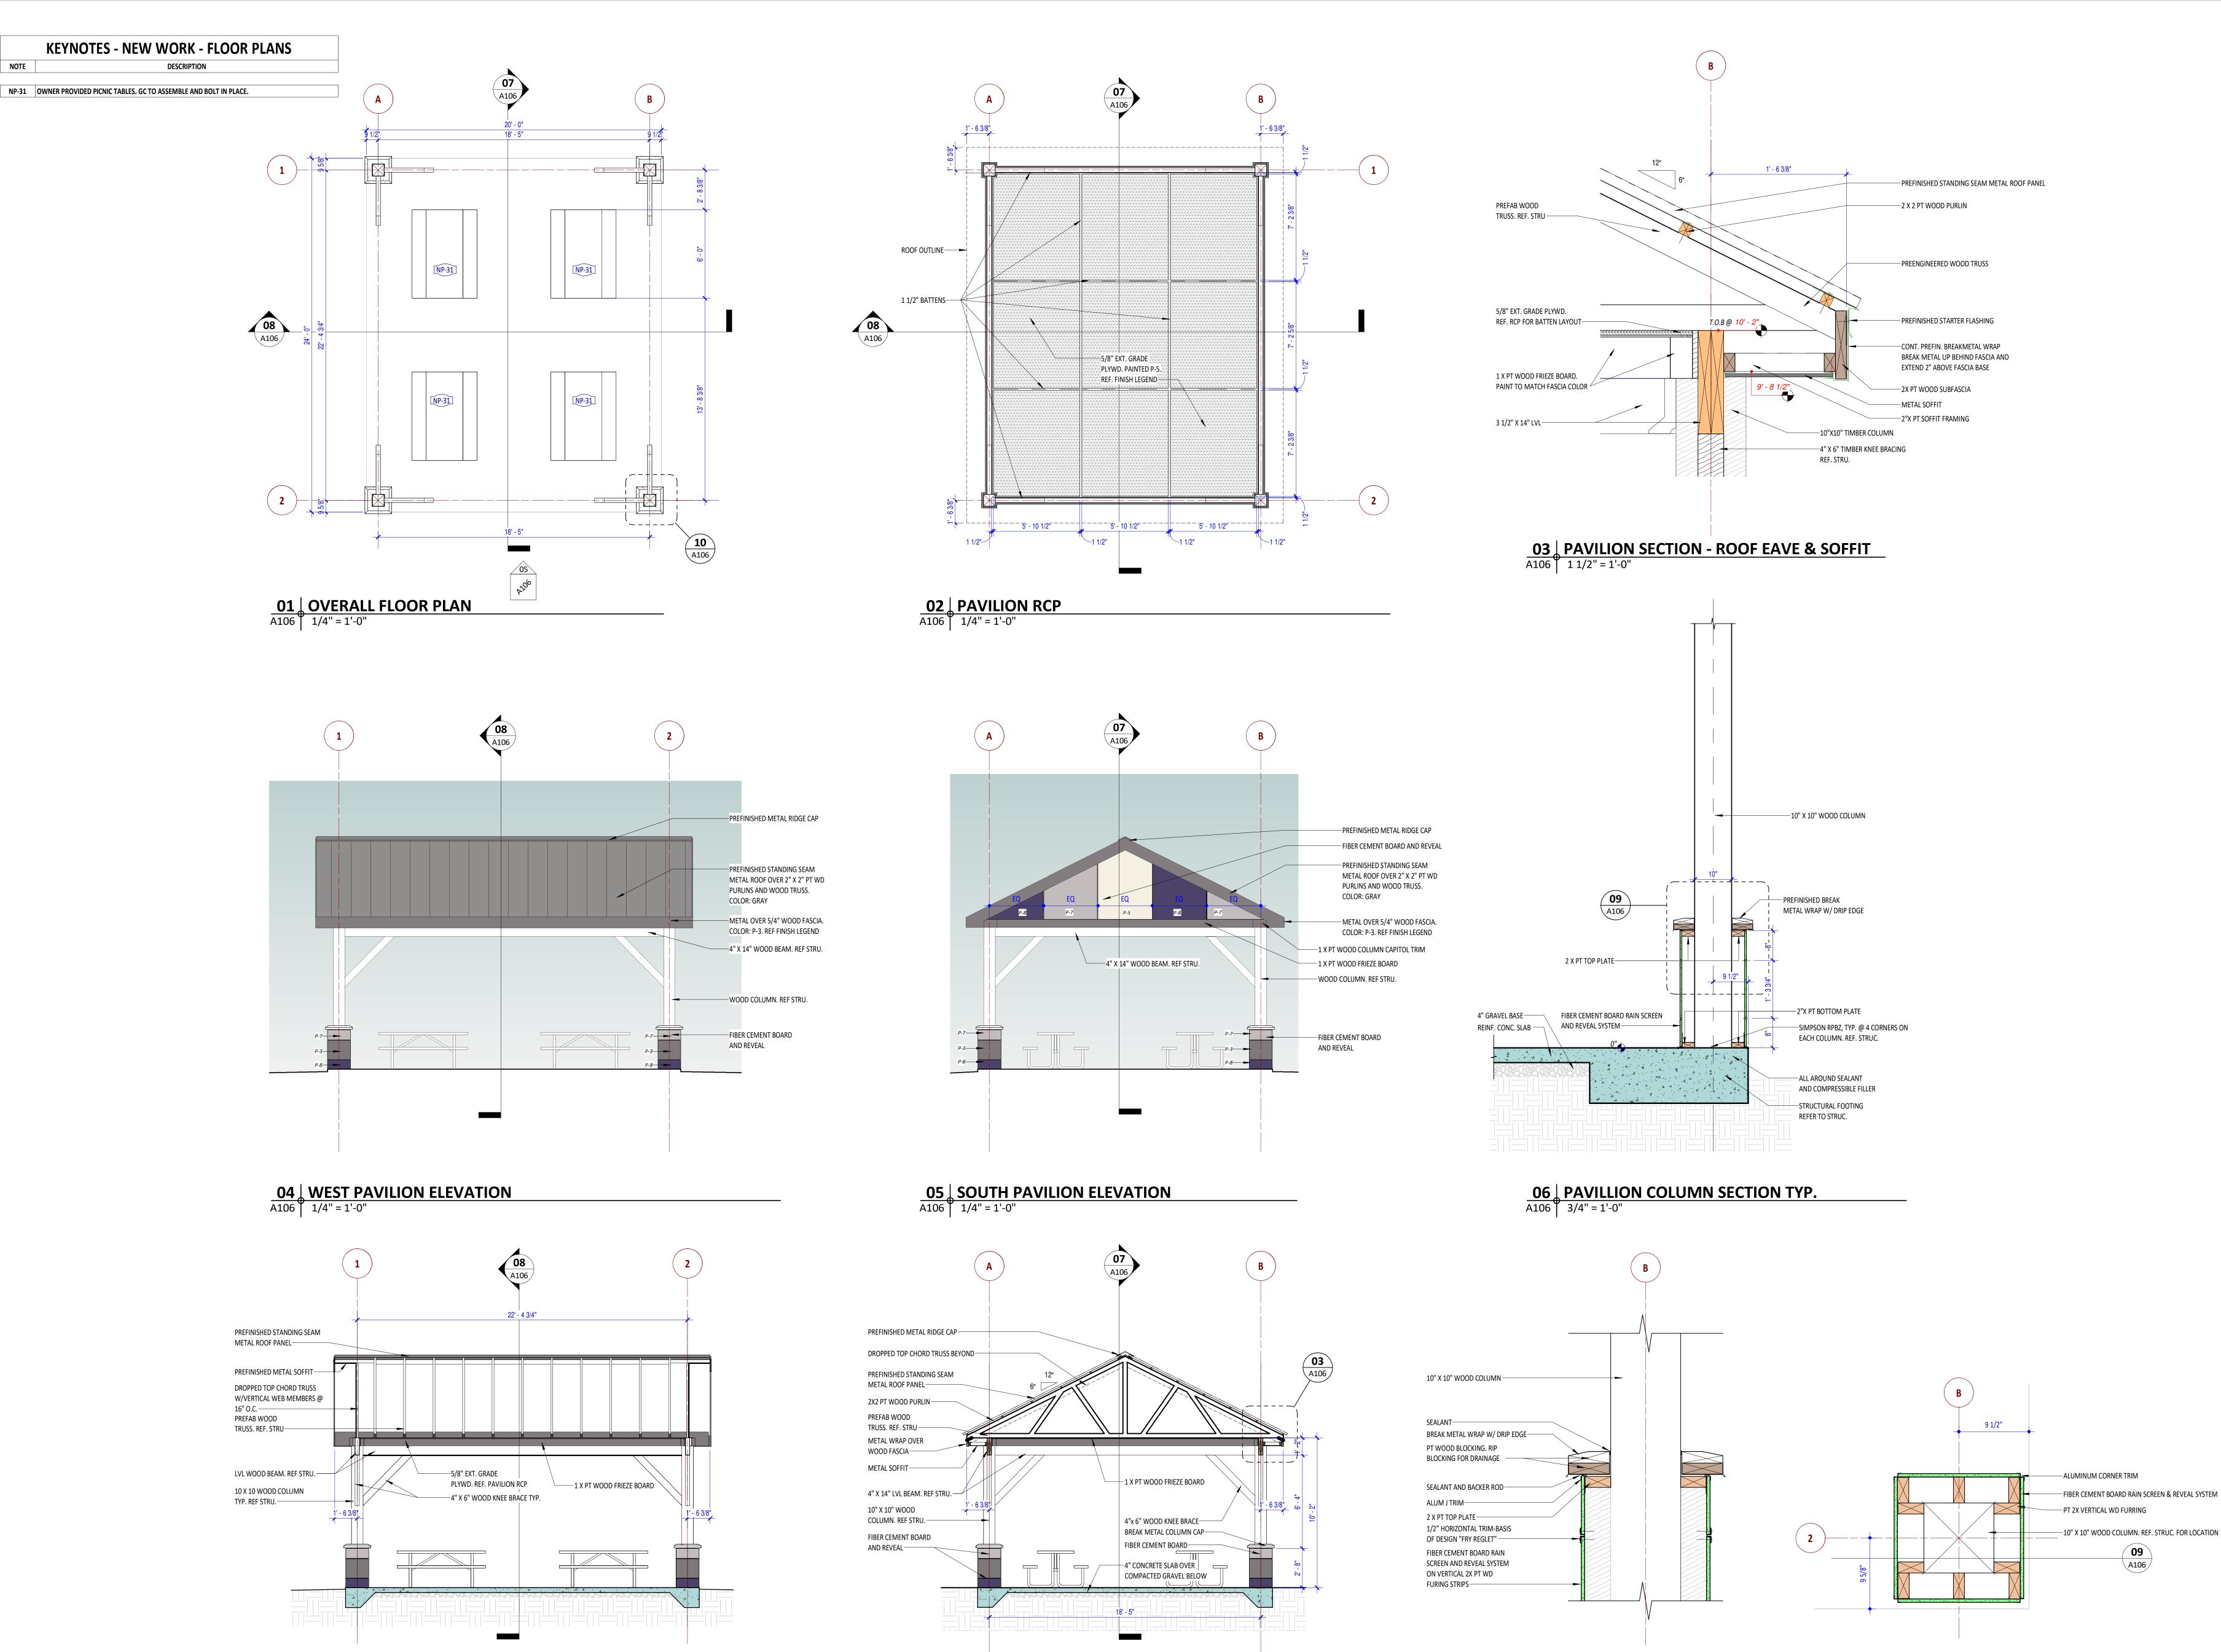

09 Detail 0 A106 1 1/2" = 1'-0"

08 PAVILION SECTIONA106 1/4" = 1'-0"

07 PAVILION SECTION 2A106 1/4" = 1'-0"

MACON, GEORGIA 31201





MACON-BIBB COUNTY PARKS AND RECREATION

CENTER RENOVATION

MEMORIAL PARK RECREATION 2465 2ND ST, MACON, GA 31206

These drawings convey certain contractual information through the use of color. Do NOT use drawings printed in black-and-white or greyscale. © 2023, WMA Architects/Planners, Inc. d/b/a WM2A Architects.


These drawings, as instruments of service, remain the property of the Architect. Unauthorized use or reproduction is forbidden Issued for Permit Revision No (if any): Revision Date:

Project No: Current Date: 2024-079 10/30/24

10 PAVILION COLUMN PLAN DETAIL
A106 1 1/2" = 1'-0"


PAVILION PLAN, **ELEVATIONS AND SECTIONS**

A106

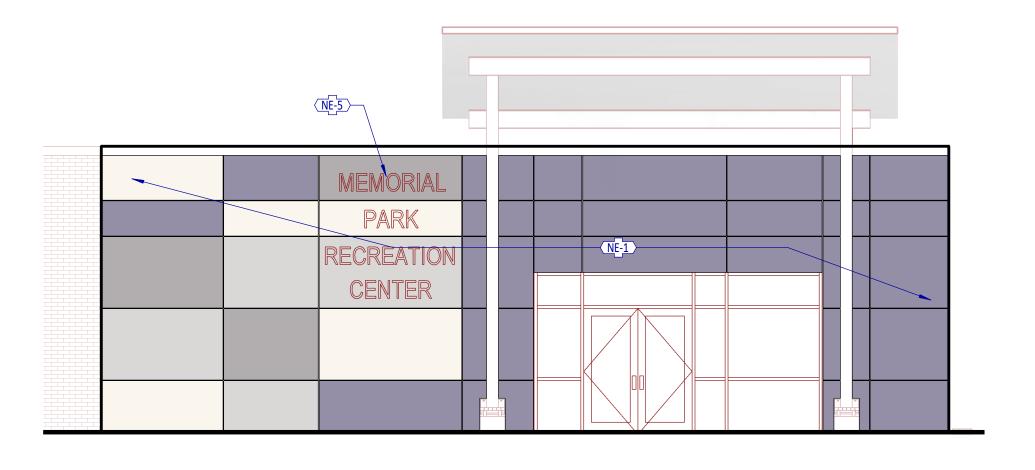


01 | ELEVATION 1 A201 | 3/16" = 1'-0"

02 | ELEVATION 2 A201 | 3/16" = 1'-0"

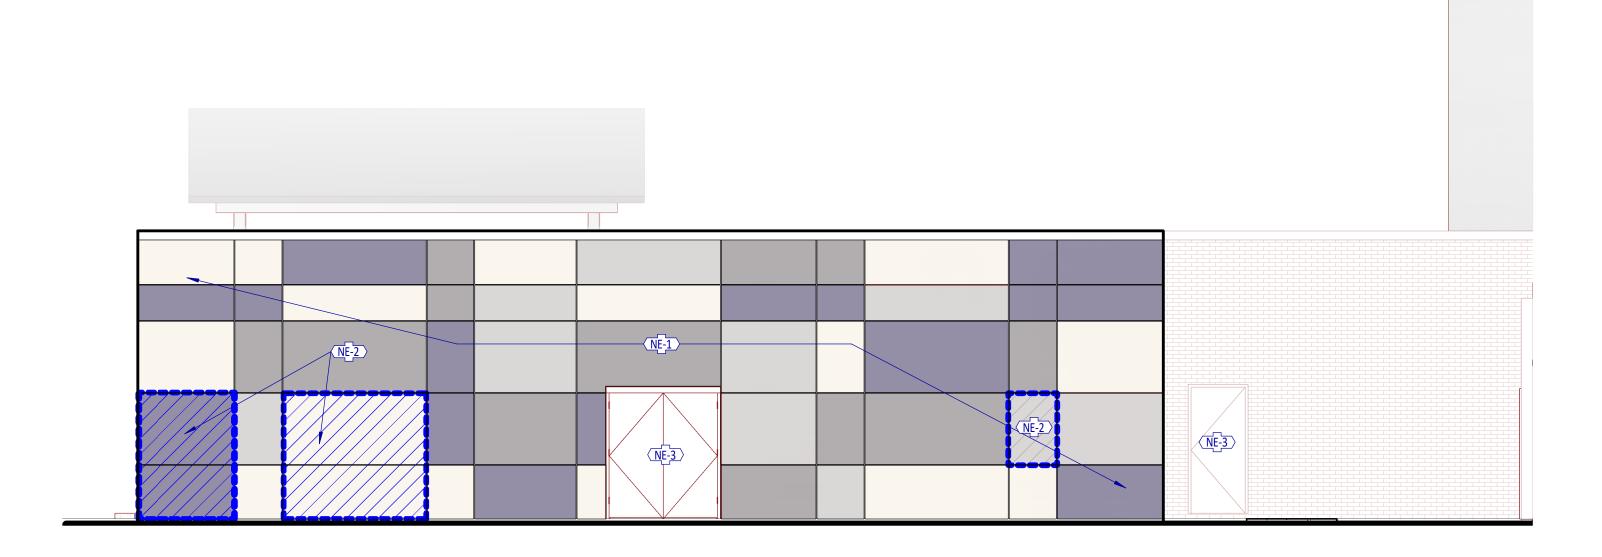


03 ELEVATION 3 A201 3/16" = 1'-0"

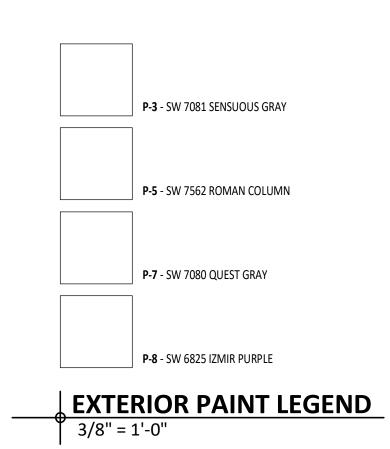


KEYNOTES - NEW WORK - ELEVATIONS

DESCRIPTION

- NE-1 PREP AND PAINT ALL EXISTING WALL PANELS. MATCH EXISTING PANEL COLORS.
- NE-2 REPLACE DAMAGED WALL PANEL. MATCH EXISTING COLOR. REF. 4/A201
- NE-3 PREP AND PAINT DOOR PANEL AND FRAME. MATCH EXISTING COLOR. ROLLER FINISH.
- NE-4 REPLACE DAMAGED WALL PANEL. MATCH EXISTING COLOR. REF. B/A201 NE-5 REMOVE AND REINSTALL SIGNAGE AS NEEDED TO REPAINT.

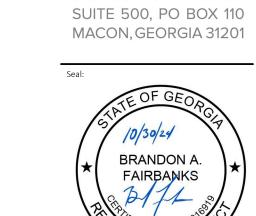

WM2A.COM348 COTTON AVENUE

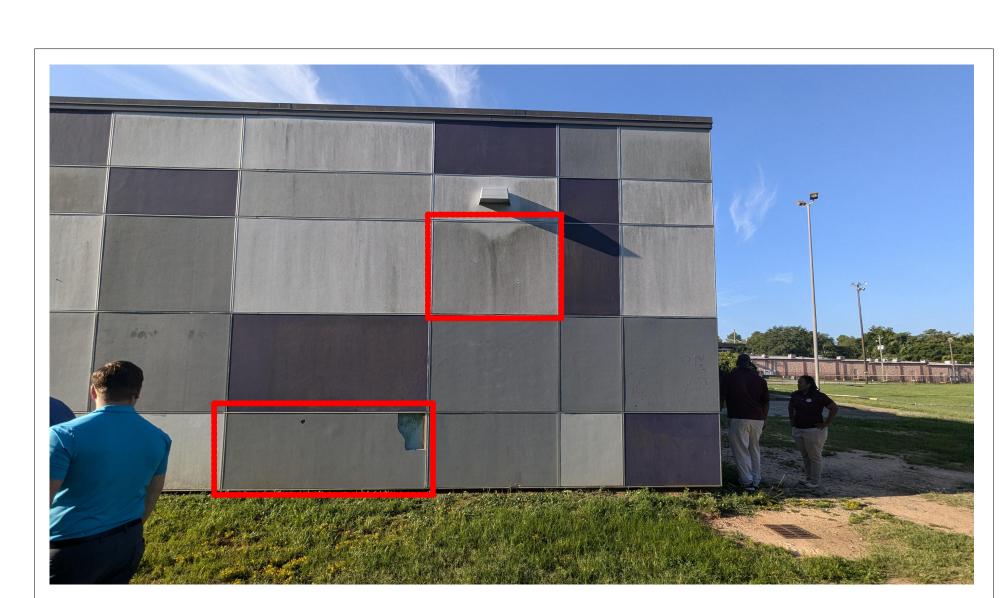





A ELEVATION 2 - PHOTOS
A201 3/16" = 1'-0"



B ELEVATION 3 - PHOTO
A201 3/16" = 1'-0"

These drawings convey certain contractual information through the use of color. Do NOT use drawings printed in black-and-white or greyscale. © 2023, WMA Architects/Planners, Inc. d/b/a WM2A Architects.

These drawings, as instruments of service, remain the property of the Architect.

Unauthorized use or reproduction is forbidden.

Issued for Permit Revision No (if any): Revision Date:


Project No: Current Date:

2024-079 10/30/24


Drawing Name:

BUILDING ELEVATIONS

A201

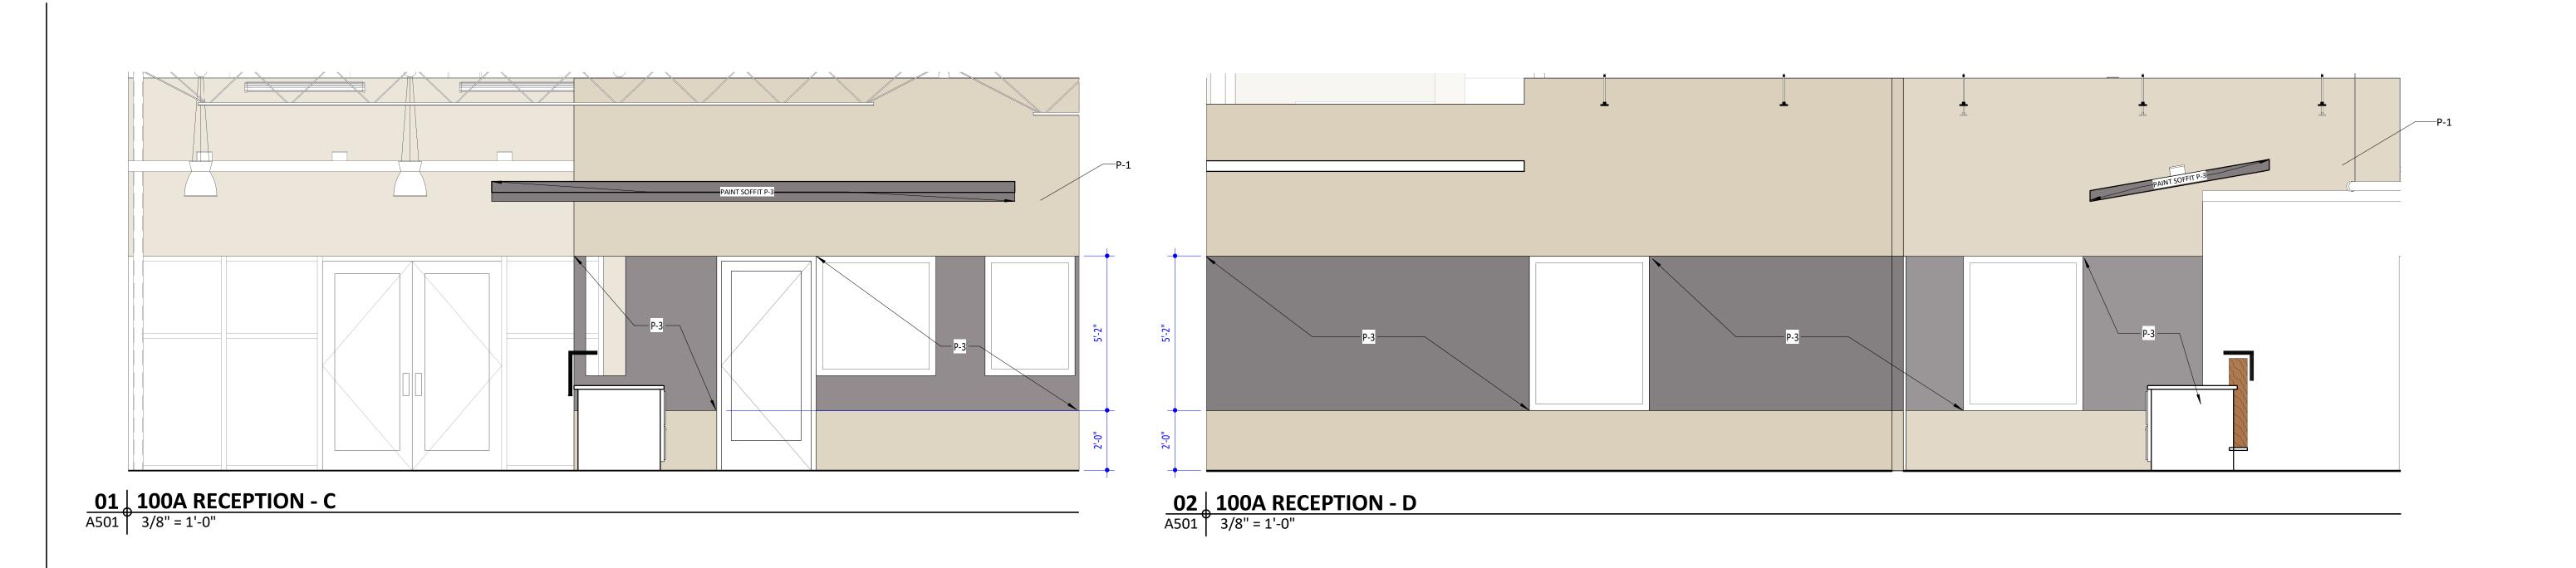



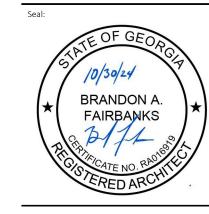






AND RECREATION


MEMORIAL PARK RECREATION
CENTER RENOVATION


2465 2ND ST, MACON, GA 31206

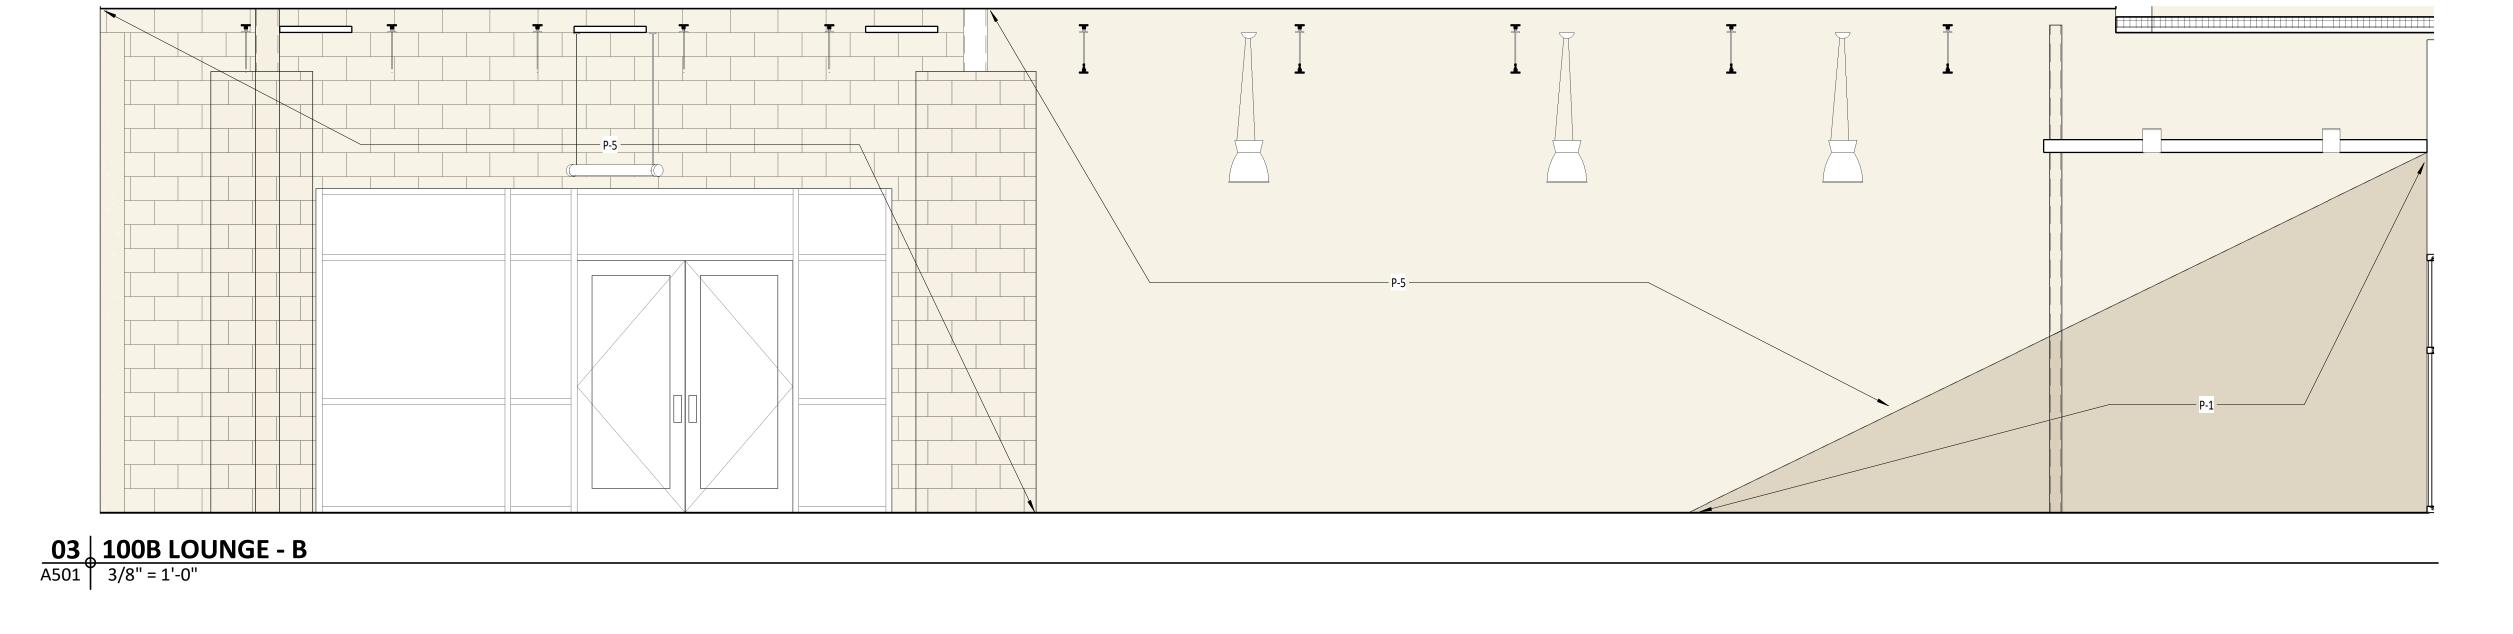

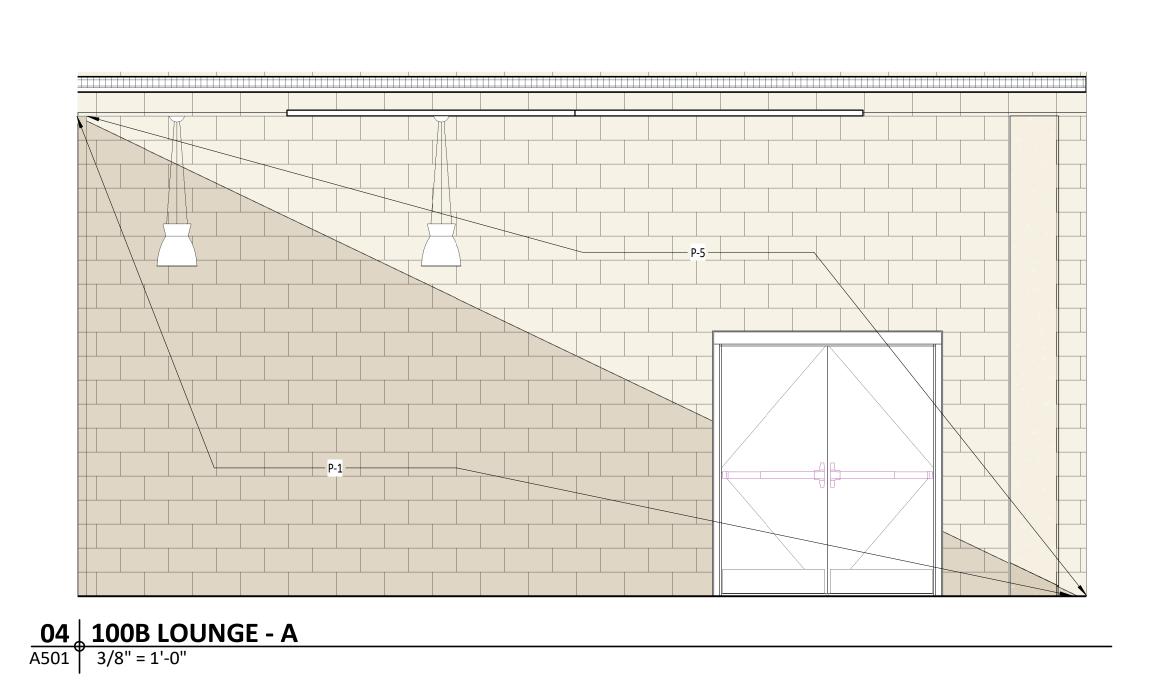

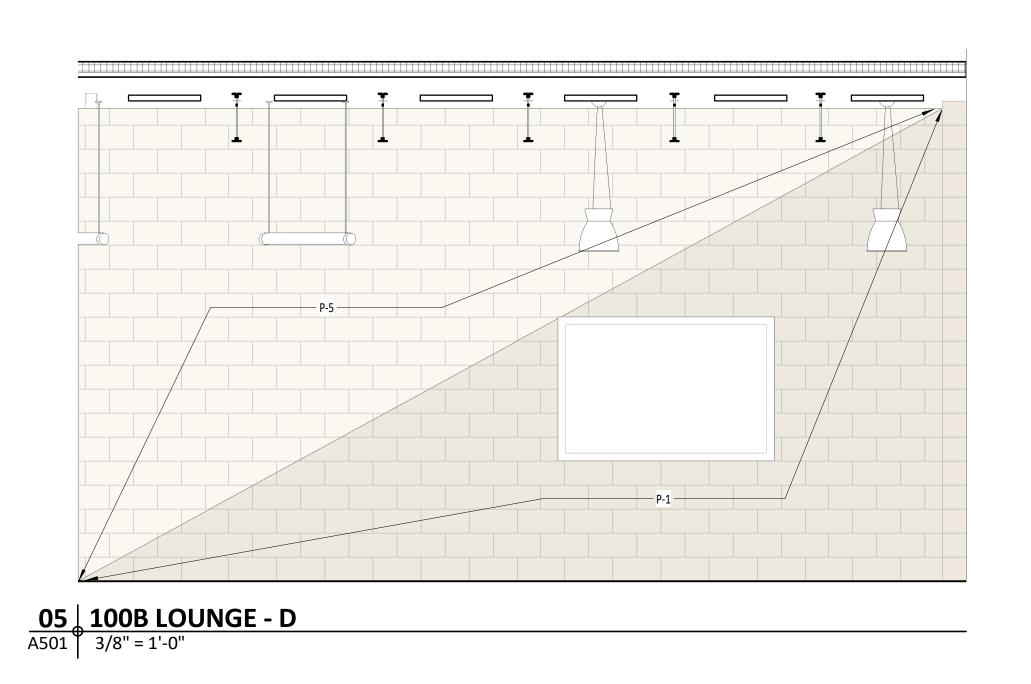

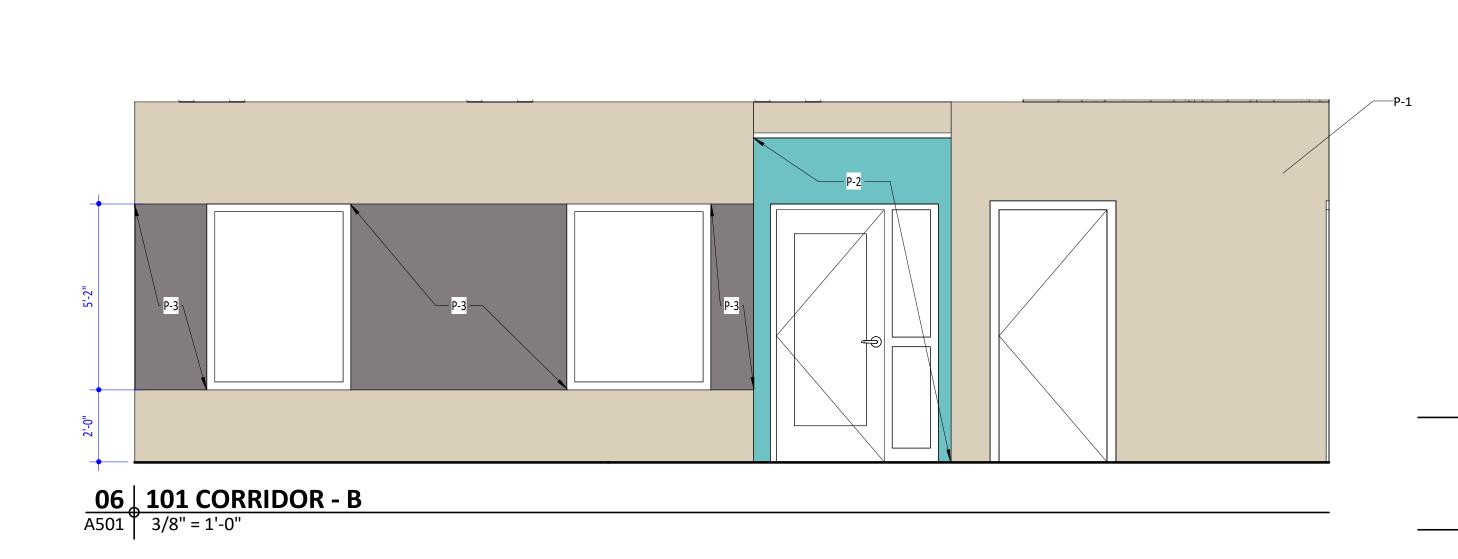

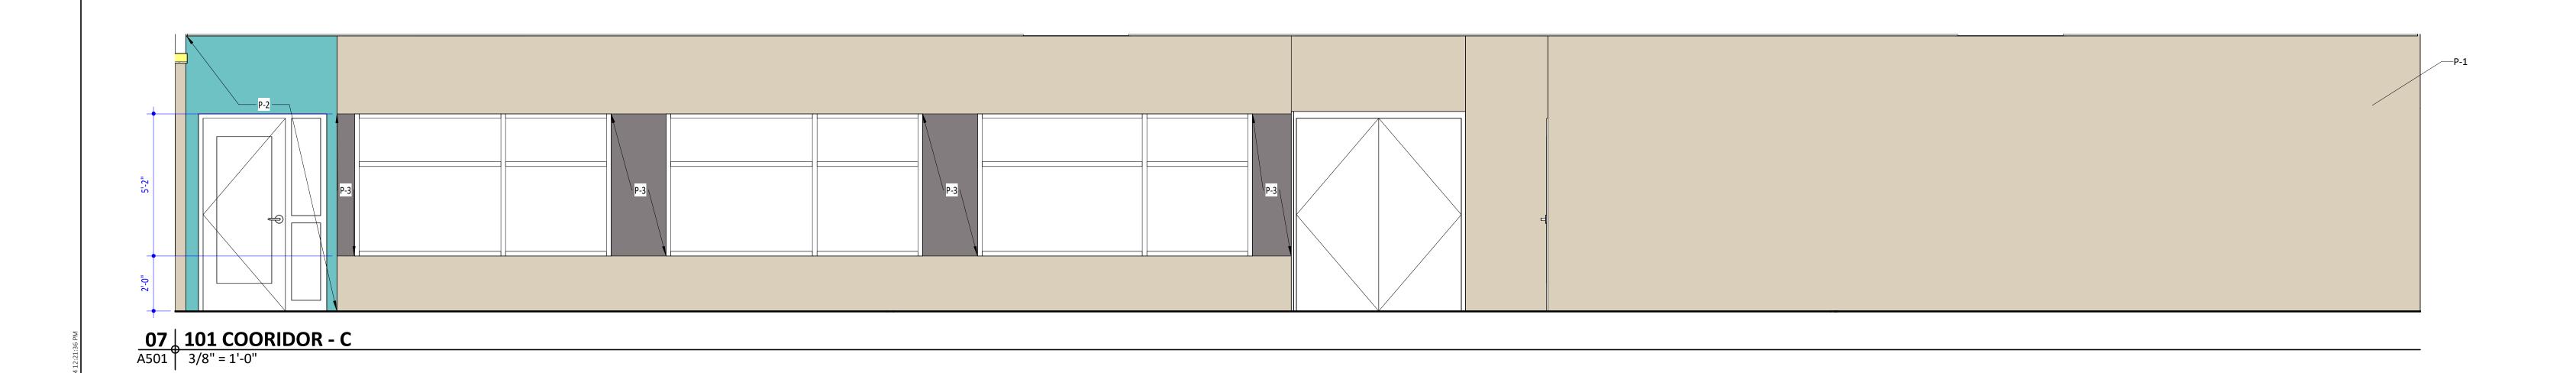

These drawings convey certain contractual information through the use of color. Do NOT use drawings printed in black-and-white or greyscale.

© 2023, WMA Architects/Planners, Inc. d/b/a WM2A Architects.
These drawings, as instruments of service, remain the property of the Architect.
Unauthorized use or reproduction is forbidden.


Revision No (if any): Revision Date:

2024-079 10/30/24

Drawing Name:

Project No: Current Date:

Drawing No:

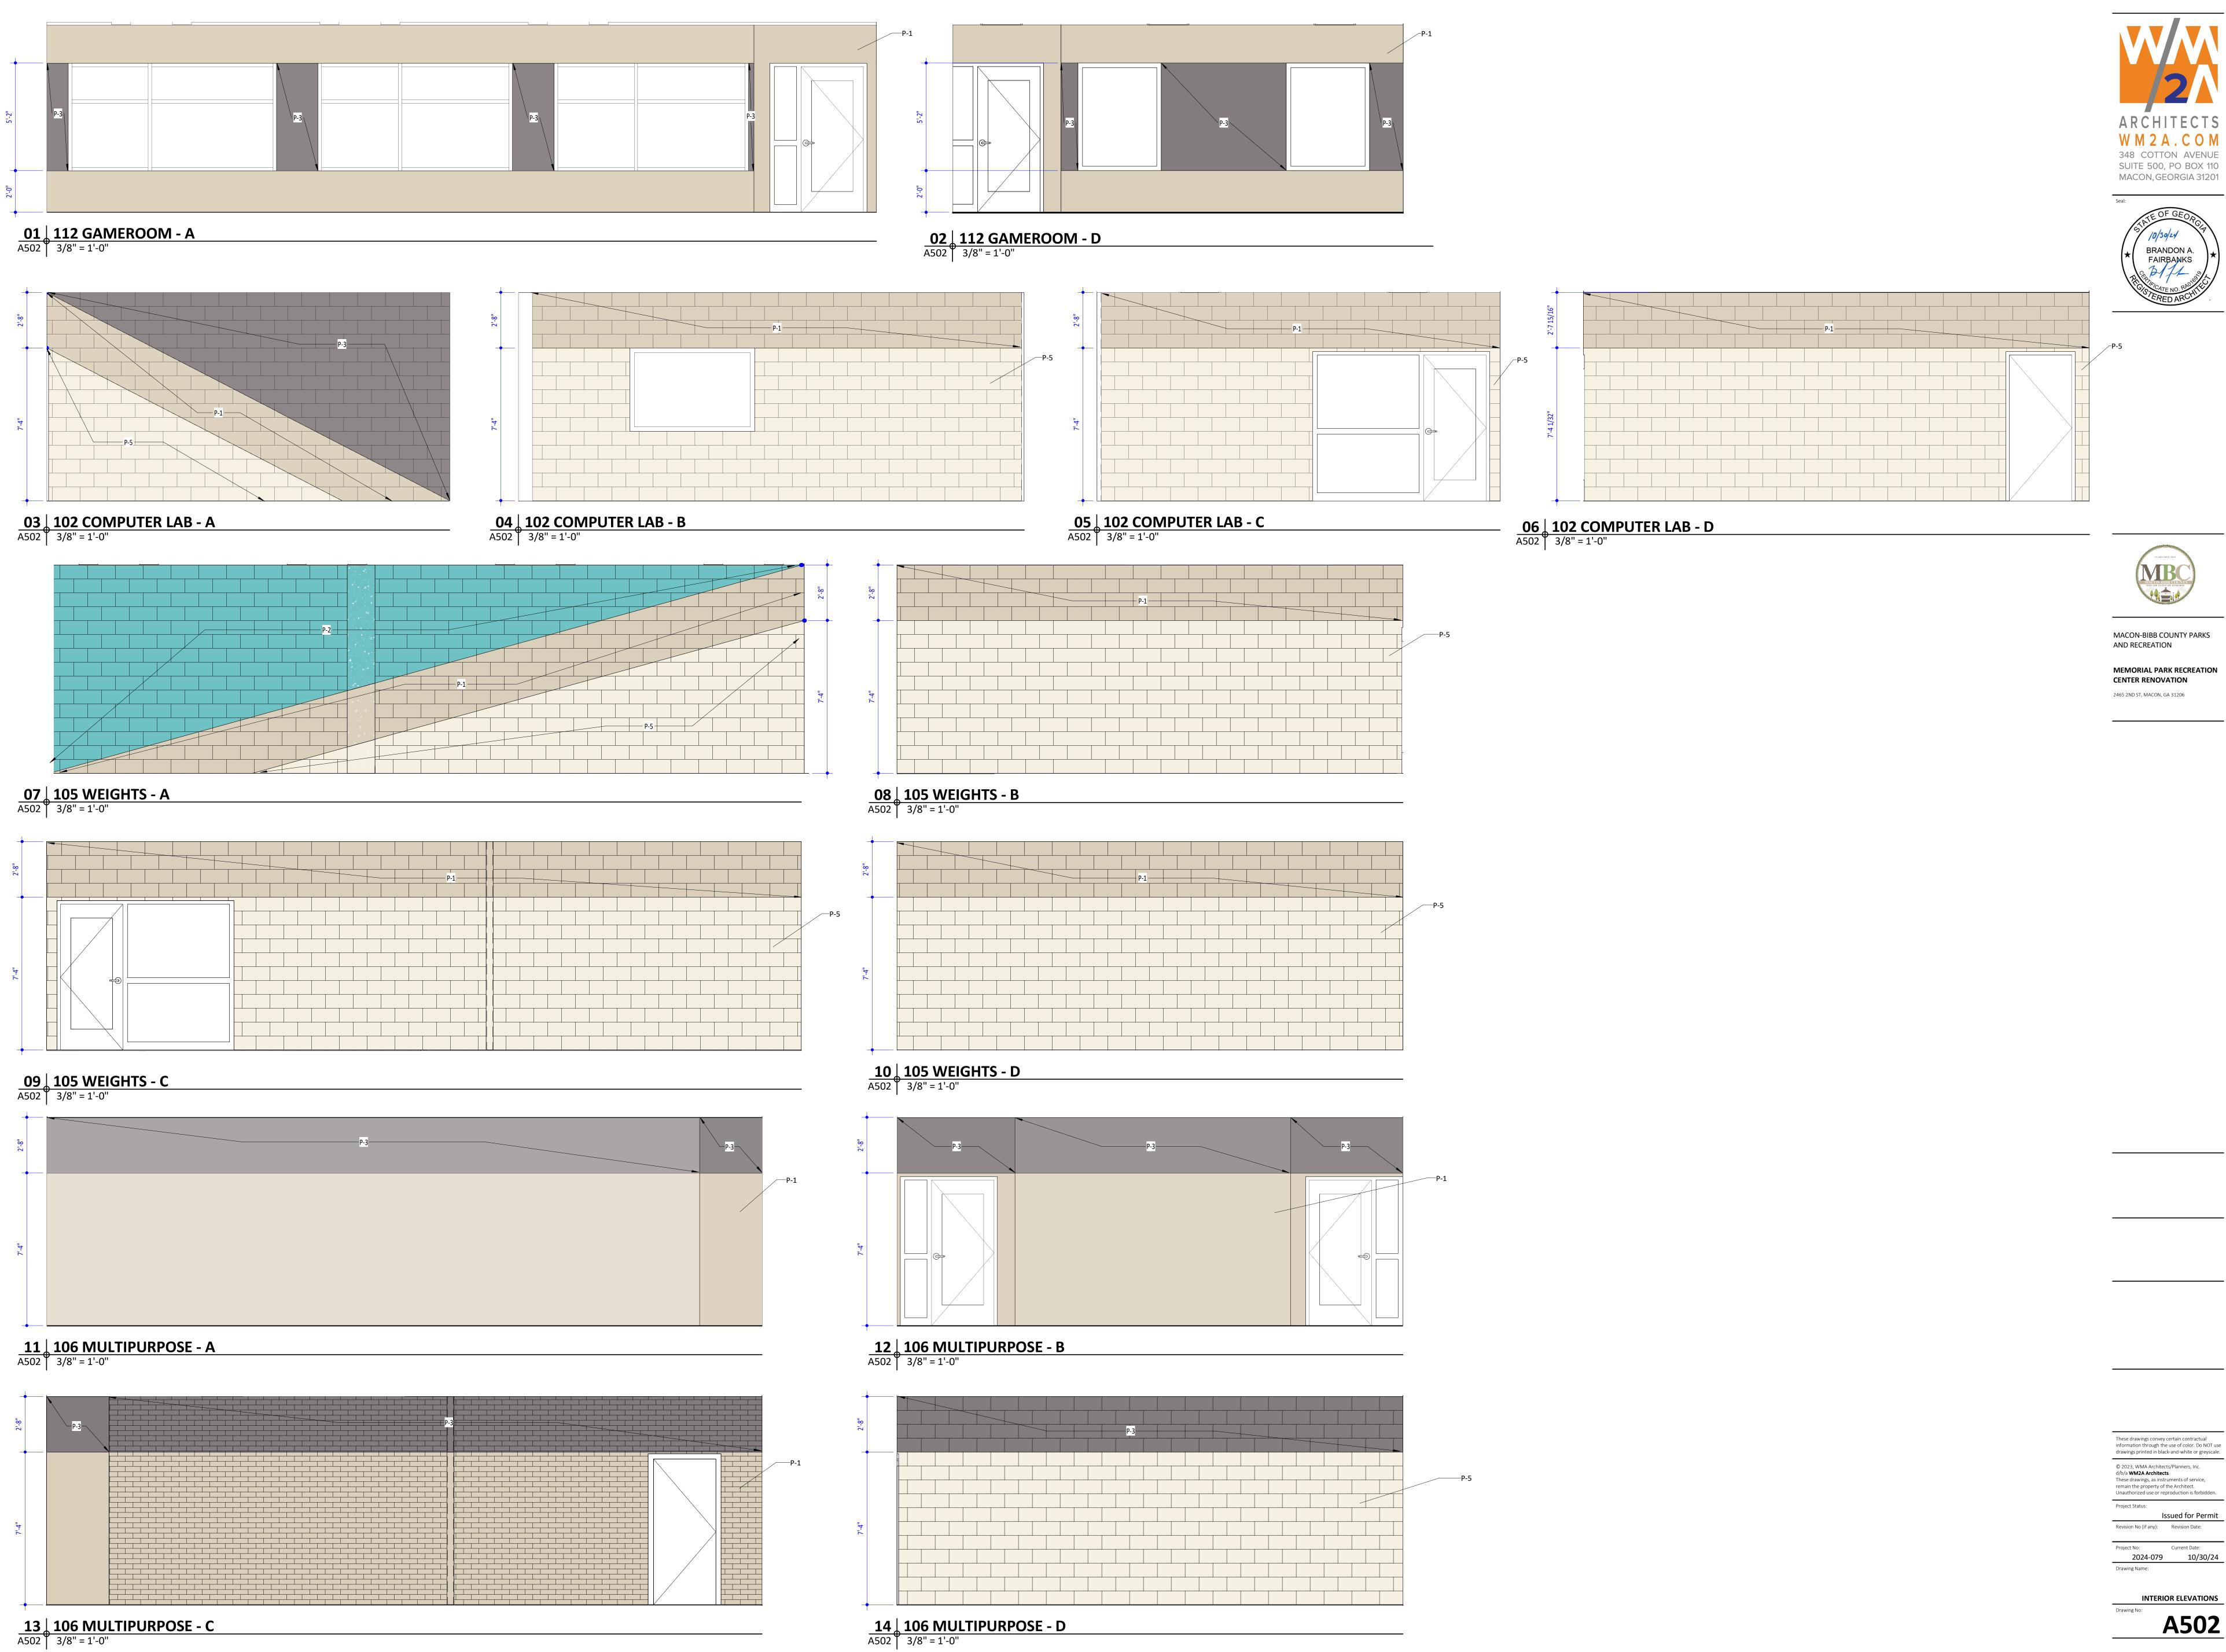

INTERIOR ELEVATIONS A502

Issued for Permit

ROOM SCHEDULE									
ROOM NUMBER	ROOM NAME	Floor Finish	Base Finish	Wall Finish	Ceiling Finish	COMMENTS			
100A	RECEPTION	VCT-4,5	WB-1	P-1,3	P-3	P-3 PAINT FLOATING SOFFIT FACE. SEE FINISH PLAN/INTERIOR ELEVATIONS FOR PAINT LOCATIONS.			
100B	LOUNGE	VCT-1,2,4,6	WB-1	P-1,5		SEE FINISH PLAN/INTERIOR ELEVATIONS FOR PAINT LOCATIONS.			
100C	LOUNGE	VCT-1,2,6	WB-1	P-1,5		SEE FINISH PLAN/INTERIOR ELEVATIONS FOR PAINT LOCATION.			
101	CORRIDOR	VCT-1,2,3,4,5,6	WB-1	P-1,2,3		SEE FINISH PLAN/INTERIOR ELEVATIONS FOR PAINT LOCATIONS.			
102	COMPUTER LAB	VCT-1	WB-1	P-1,3,5		SEE FINISH PLAN/INTERIOR ELEVATIONS FOR PAINT LOCATIONS.			
102A	STOR.	VCT-1	WB-1	P-1		-			
103	WOMEN'S	EXG	EXG	P-1		-			
104	MEN'S	EXG	EXG	P-1		-			
105	WEIGHTS	EXG	EXG	P-1,2,5		FLOORING TO REMAIN. SEE FINISH PLAN/INTERIOR ELEVATIONS FOR PAINT LOCATIONS.			
106	MULTIPURPOSE	F-1	F-1	P-1,3		SEE FINISH PLAN/INTERIOR ELEVATIONS FOR PAINT LOCATION.			
107	VEST.	VCT-2	WB-1	P-1		-			
108	MEETING ROOM	VCT-1,2,4,6	WB-1	P-1,3,5		SEE FINISH PLAN/INTERIOR ELEVATIONS FOR PAINT LOCATION.			
109	KITCHEN	VCT-2	WB-1	P-1		-			
112	GAME ROOM	VCT-1,2,4,6	WB-1	P-1,3		SEE FINISH PLAN/INTERIOR ELEVATIONS FOR PAINT LOCATIONS.			
113	OFFICE	VCT-2	WB-1	P-1		-			
115	OFFICE	VCT-2	WB-1	P-1		-			
117	OFFICE	VCT-2	WB-1	P-1		-			

117	OFFICE VC1	T-2 WB-1	P-1	-	
			FINISHES - F	I OORS	
Floor Finish	FloorType	Manufacturer	Style and Color	Image	Comments
			otyle and delet		Comments
EPOXY-1	EPOXY	Sherwin Williams	SW DECO QUARTZ - PEPPERED GRANITE		
Resilient					
F-1	Resilient	Armstrong Homogenous	Natralis Meadow		Install per manufacturers specifications.
Vinyl Composition	Tile				
VCT-1	Vinyl Composition Tile	Armstrong	Desert Dust 52128		Install per manufacturers specifications.
VCT-2	Vinyl Composition Tile	Armstrong	Linseed 5C236		Install per manufacturers specifications.
VCT-3	Vinyl Composition Tile	Armstrong	Bay Blue 57541		Install per manufacturers specifications.
VCT-4	Vinyl Composition Tile	Armstrong	Blueberry 51881		Install per manufacturers specifications.
VCT-5	Vinyl Composition Tile	Armstrong	Tiger Eyes 57533		Install per manufacturers specifications.
				Eleka Shiringa Maria	


		FINISHES	S - WALLS	
Wall Finish	Manufacturer	Style and Color	Image	Comments
WT-1	Daltile	AC23 Coconut Rectangle Hancrafted Glossy, Rectangle 3"x12" - Offset Pattern Install		Alternative design choice for Dressing Rooms 122 & 123: WT-1
Paint				
P-1 General	Sherwin Williams	OYSTER BAR SW 7565		Provide two coats.
P-2	Sherwin Williams	MARINER SW 6766		Accent Paint
P-3	Sherwin Williams	SENSUOUS GRAY SW 7081		Accent Paint
P-4	Sherwin Williams	PORPOISE SW 7047		Trim, Frame & Door Paint
P-5	Sherwin Williams	ROMAN COLUMNS SW7562		
P-7	Sherwin Williams	QUEST GRAY SW 7080		
P-8	Sherwin Williams	IZMIR PURPLE SW 6825		

56790 Black

2" x 24" Strip


	FINISHE	S - BASE			FINISHES -	CEILING		Roppe #21; Tarkett RRS-XX-B (B=.080") Burke 633; Roppe #22; Tarkett RRS-XX-C (B=1/8")	Roppe #59; Tarkett SSR-XX-D
Base Finish	Manufacturer Style and Color Image	Comments	Ceiling Finish	Manufacturer	Style and Color	Image	Comments	α I	080
Resilient			Paint	_				1"	1"
WB-1	Roppe 114 LUNAR DUST		P-6	SHERWIN WILLIAMS	SW 7007 CEILING BRIGHT WHITE		PAINT NEW CEILINGS	Provide edge strip wherever resilient flooring abuts concrete slab. Size to match flooring thickness (B).	Provide reducer strip resilient flooring abur of different thickness

er strip wherever ng abuts resilient flooring

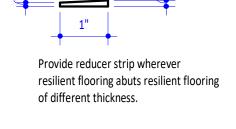


O2 Resilient Edge Strip
A701 6" = 1'-0"

O3 Resilient Reducer Strip
A701 6" = 1'-0"

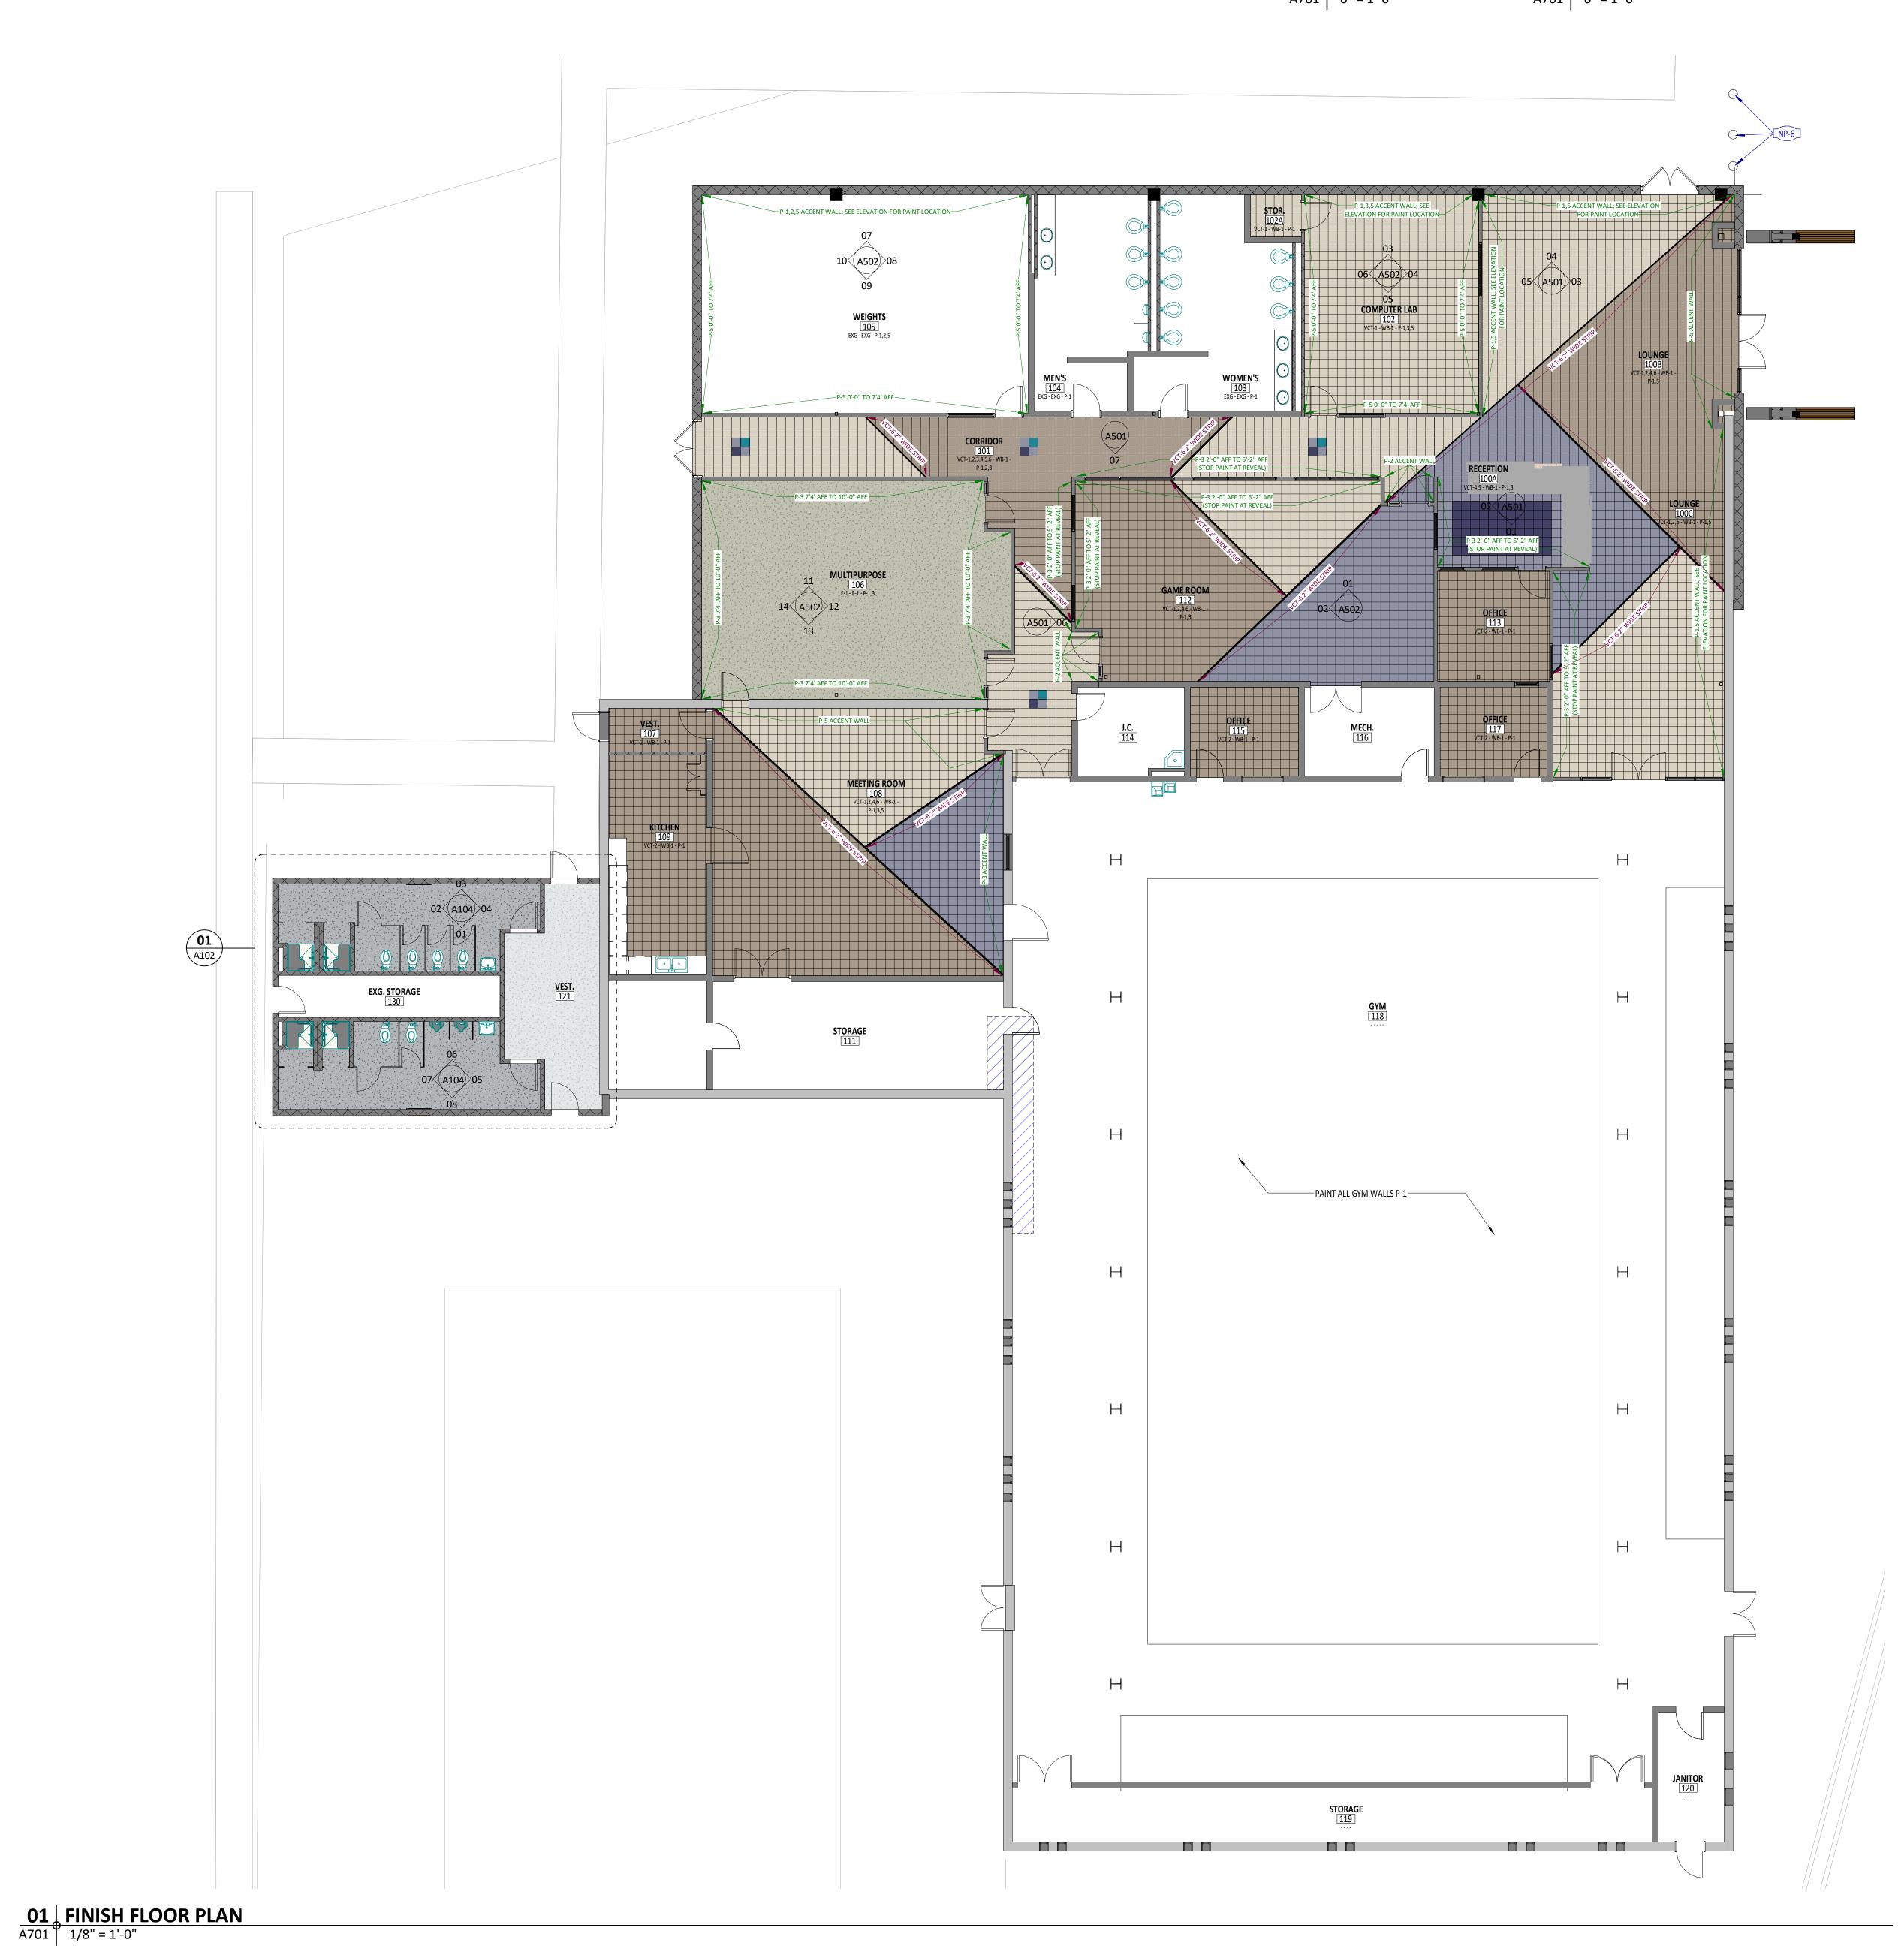



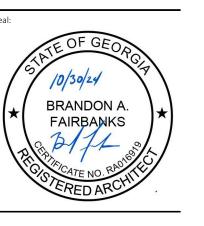



MACON-BIBB COUNTY PARKS AND RECREATION

MEMORIAL PARK RECREATION CENTER RENOVATION 2465 2ND ST, MACON, GA 31206

These drawings convey certain contractual information through the use of color. Do NOT use drawings printed in black-and-white or greyscale. © 2023, WMA Architects/Planners, Inc. d/b/a WM2A Architects.
These drawings, as instruments of service, remain the property of the Architect.
Unauthorized use or reproduction is forbidden.

Issued for Permit Revision No (if any): Revision Date: Project No: Current Date: 2024-079 10/30/24

Drawing Name:

FINISH PLAN, SCHEDULE,

AND LEGEND A701










MEMORIAL PARK RECREATION CENTER RENOVATION











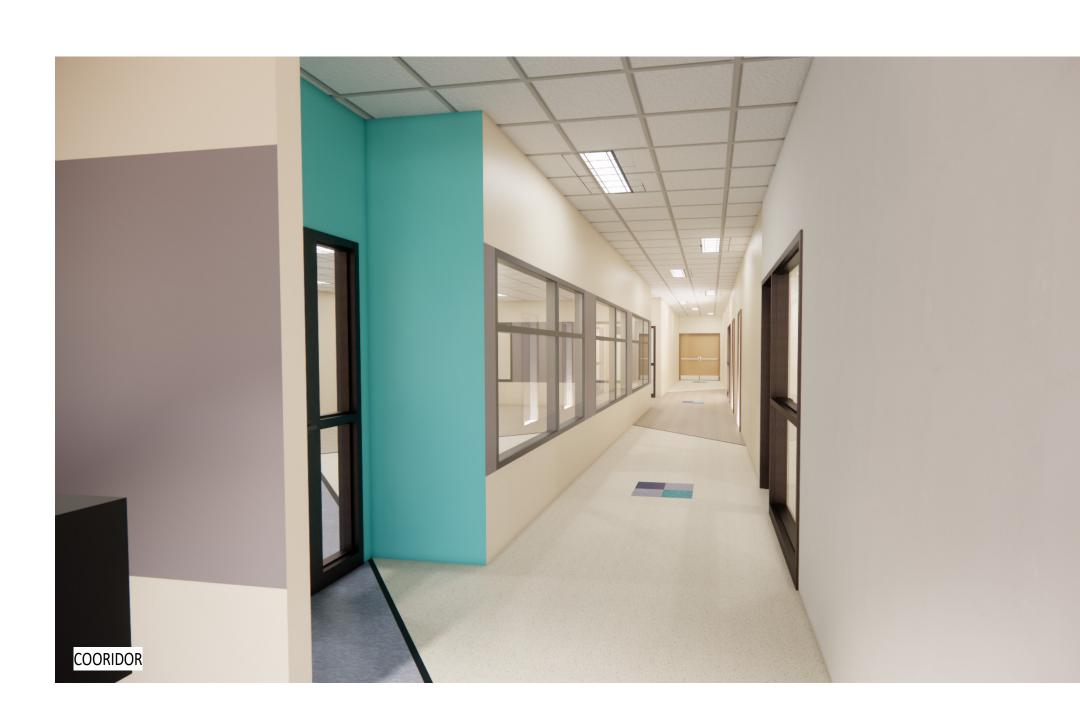

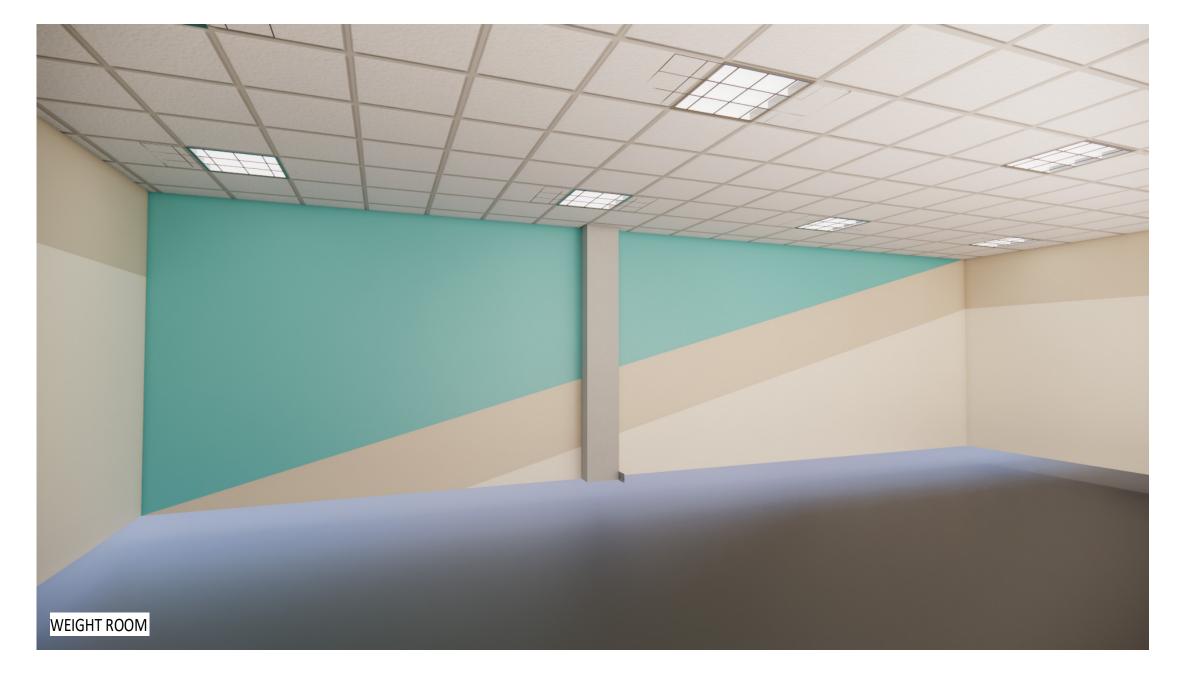

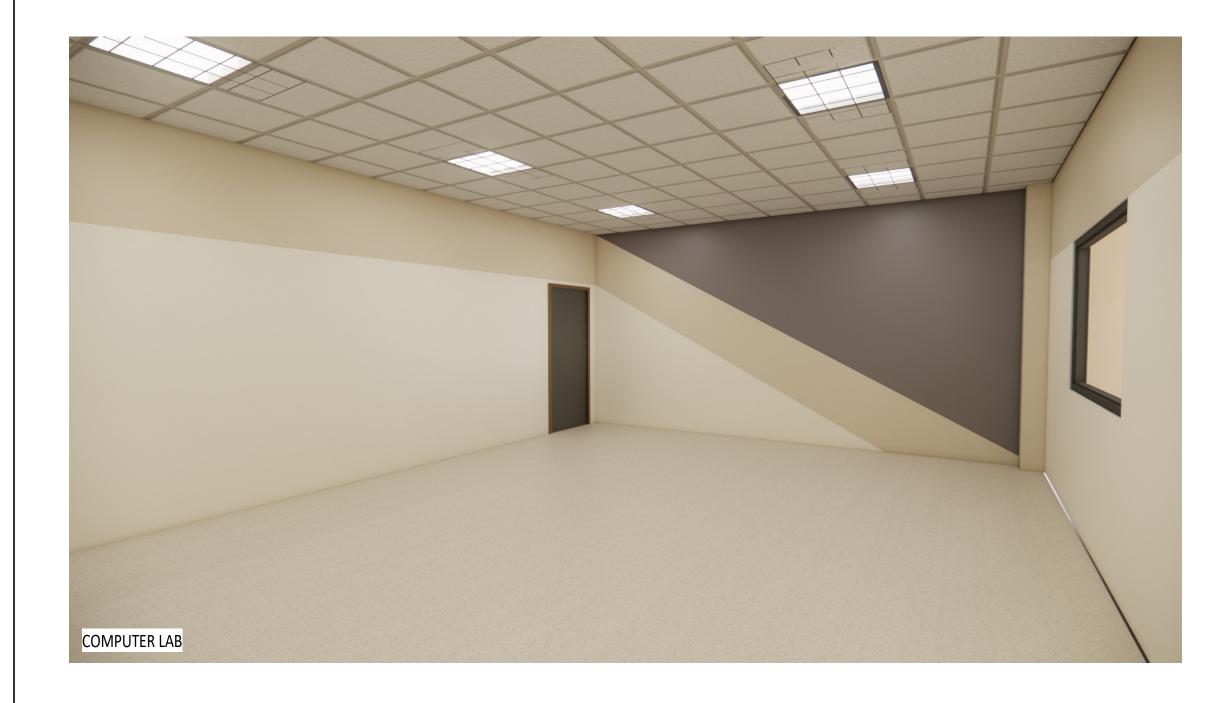

ENTRY/ LOUNGE

These drawings convey certain contractual information through the use of color. Do NOT use drawings printed in black-and-white or greyscale. © 2023, WMA Architects/Planners, Inc. d/b/a **WM2A Architects**.
These drawings, as instruments of service, remain the property of the Architect.
Unauthorized use or reproduction is forbidden.


Project Status: Revision No (if any): Revision Date:


2024-079 10/30/24


Drawing Name:

Project No: Current Date:

INTERIOR 3D VIEWS A702

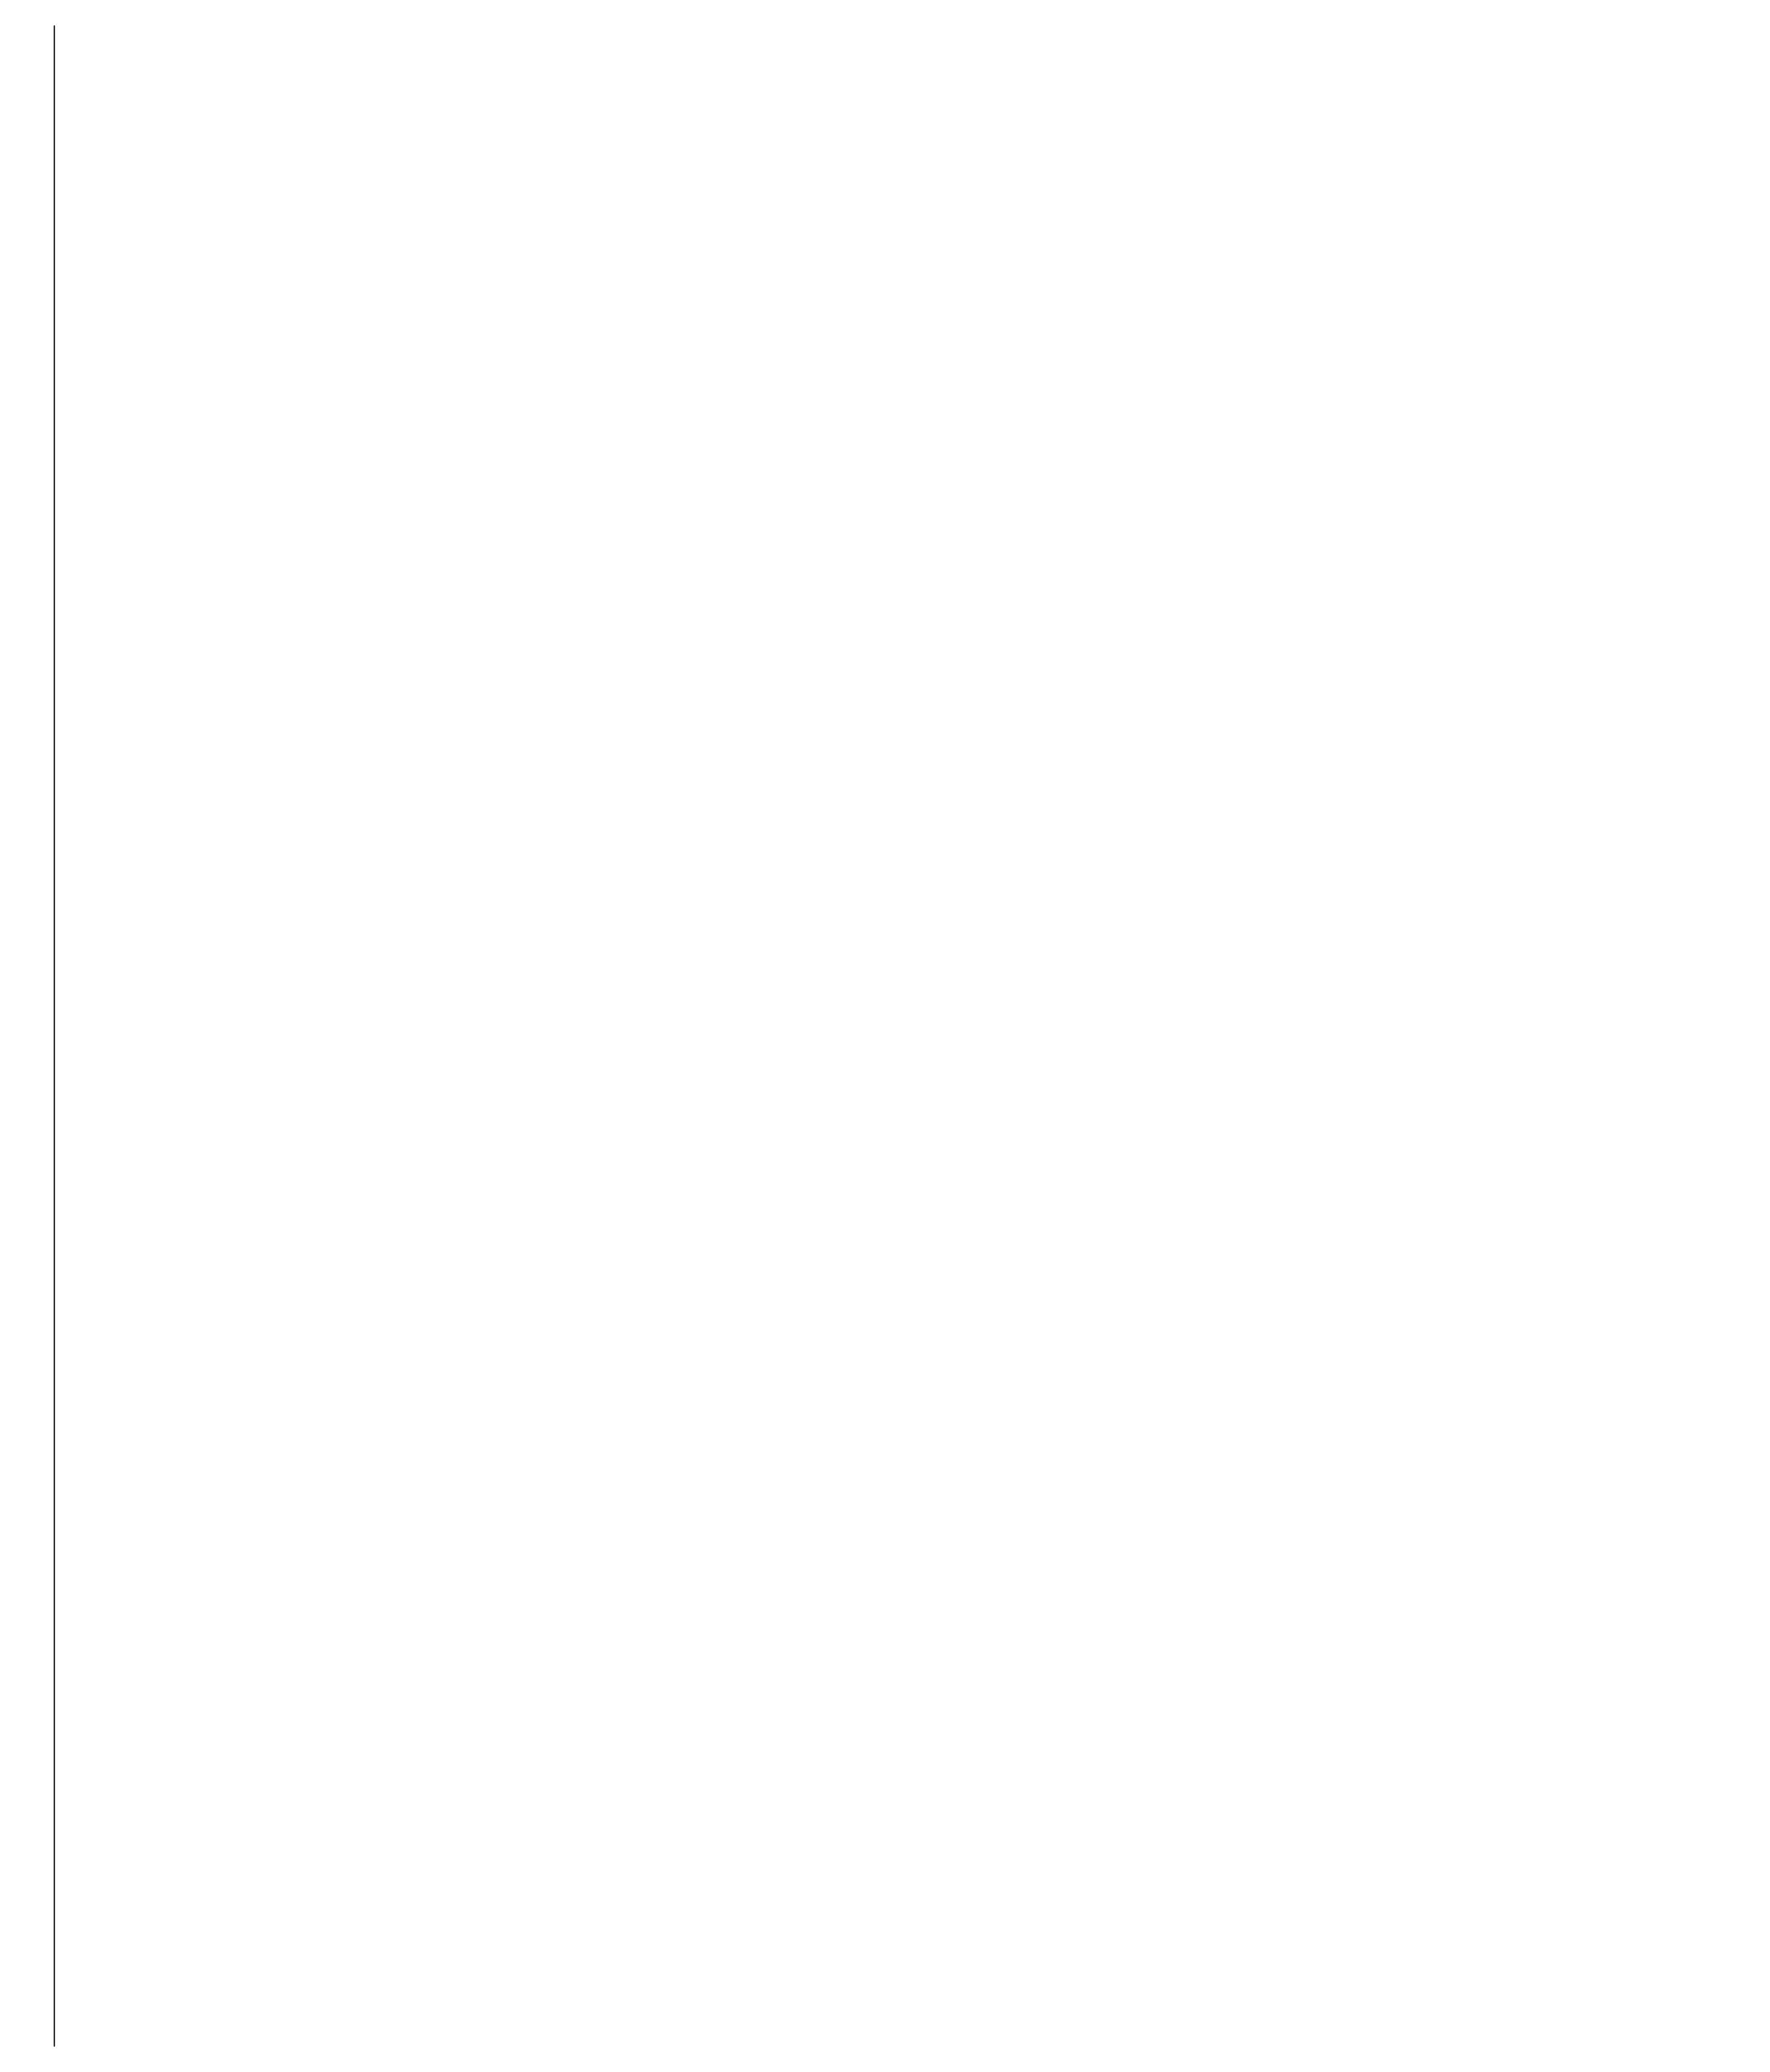

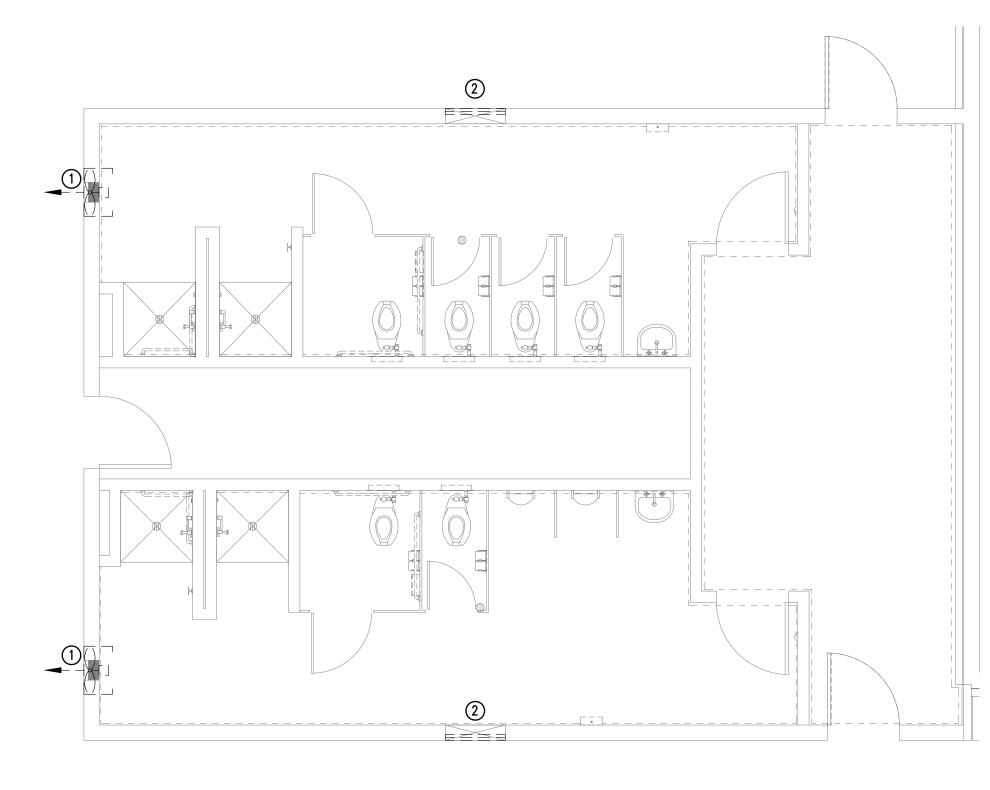

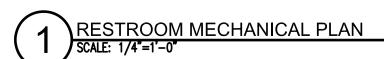

LII	ne legend
////////	DEMOLITION
	EXISTING TO REMAIN
→	CONNECT TO EXISTING

KEY NOTES(THIS SHEET ONLY):

1 EXISTING EXHAUST FAN SHALL REMAIN AS IS. CONTRACTOR SHALL PERFORM GENERAL MAINTENANCE WORK. REPLACE APPARENT DEFECTIVE PARTS. CONTRACTOR SHALL CLEAN EXISTING FAN AND IT ACCESSORIES.

2 EXISTING LOUVER SHALL REMAIN AS IS. CONTRACTOR SHALL DO GENERAL MAINTAIN WORK ON LOUVER. CONTRACTOR SHALL CLEAN EXISTING LOUVER.

GENERAL DEMOLITION NOTES

A) DRAWINGS ARE DIAGRAMMATIC AND SHOW THE GENERAL PROXIMITY OF EQUIPMENT, PIPES, DUCTWORK ETC., ARE NOT TO BE SCALED. ALL DIMENSIONS SHALL BE VERIFIED BY THE CONTRACTOR AT BUILDING SITE.

B) THE DEMOLITION PLANS HAVE BEEN PREPARED TO ASSIST THE CONTRACTOR IN DETERMINING THE SCOPE OF DEMOLITION WORK AND SHOULD NOT BE CONSTRUED TO BE ALL OF DEMOLITION REQUIRED. THE CONTRACTOR SHALL VISIT JOB SITE (AFTER CAREFULLY REVIEWING THE CONTRACT DOCUMENTS) AND DETERMINE EXACT AREAS AND QUANTITIES OF EXISTING MATERIALS TO BE REMOVED TO ACCOMPLISH NEW CONSTRUCTION.

C) WHERE THE DOCUMENTS INDICATE EQUIPMENT TO BE REMOVED OR DEMOLISHED. CONTRACTOR SHALL REMOVE ALL ASSOCIATED MATERIALS INCLUDING SUPPORT, HANGERS, AND ASSOCIATED ACCESSORIES.

D) CONTRACTOR SHALL DISPOSE OF ANY MATERIAL TO BE DISCARDED IN ACCORDANCE WITH ALL LAWS AND


REGULATIONS.

E) WE RECOMMEND QUALIFIED FIRM TO EVALUATE THE EXISTING UNITS AND PROVIDE A DEFICIENCY REPORT FOR EACH EQUIPMENT TO OWNER. CONTRACTOR SHALL PERFORM GENERAL MAINTENANCE WORK ON UNITS. THESE WORK INCLUDES PROVIDING NEW BELTS

ON MOTORS, CLEAN FANS AND DUCTWORK.

F) UNUSED SLEEVES LEFT OPEN BY REMOVAL OF PIPING SHALL BE CUT FLUSH WITH THE FINISHED SLAB OR WALL, FILLED WITH NON-SHRINKING GROUT AND/OR FIRE RATED FOAM FLUSH WITH BOTH SIDES OF SLAB OR WALL TO MAINTAIN SLAB OR WALL FIRE RATING.

G) ALL EXISTING EQUIPMENT REMOVED OR DEMOLISHED SHALL BE A PROPERTY OF THE CONTRACTOR, UNLESS OTHERWISE NOTED AND SHALL BE REMOVED FROM THE FACILITY AS REQUIRED BY CODES AND REGULATIONS.

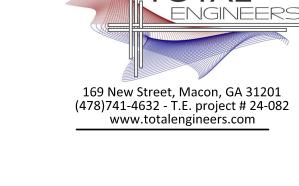


MACON, GEORGIA 31201

MACON-BIBB COUNTY PARKS AND RECREATION

MEMORIAL PARK REC. CENTER RENOVATION PROJECT

2465 2ND ST, MACON, GA 31206

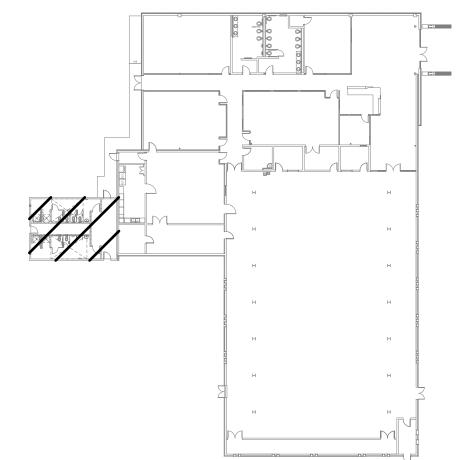

KEYED PLAN

These drawings convey certain contractual information through the use of color. Do NOT use drawings printed in black-and-white or greyscale.

© 2023, WMA Architects/Planners, Inc. d/b/a WM2A Architects .

These drawings, as instruments of service, remain the property of the Architect.

Unauthorized use or reproduction is forbidden.

Revision No (if any): Revision Date:

Project No: Current Date:
2024-079 10/30/2024

Drawing Name:

MECHANICAL PLAN

M101

PLUMBING SPECIFICATIONS

Provide all plumbing items indicated on the drawings, described herein or otherwise required for a complete and proper installation, including:

A. Plumbing fixtures, fittings and equipment.

B. Hot and cold water systems.

C. Drain waste and vent piping systems.

D. Indirect waste piping, including all valves, traps, piping and accessories for all equipment. Size per equipment requirements.

Comply with all applicable codes, standards and ordinances, including requirements of the Georgia State Minimum Standard Plumbing Code (2018 International Plumbing Code with all Georgia State Amendments), Georgia State Minimum Standard Energy Code (2015 International Energy Conservation Code with all Georgia State supplements and Amendments), and the DOJ 2010 ADA Standards for Accessible Design with Georgia Amendments of Rule 120—3—20.

The contractor should not attempt to precisely scale dimensions from these drawings to obtain construction dimensions and clearance. The contractor shall verify all actual dimensions and clearances. Although these plans are diagrammatic in nature, they shall be followed as closely as site conditions, new construction, and work by other trades shall permit. Deviations from these drawings, which are required to conform to the available space or to actual building construction, shall be made at no additional cost to the owner.

The submission of a bid or proposal will be construed as evidence that the contractor has familiarized himself with the plans and building site. Claims made subsequent to the proposal for materials and/or labor due to difficulties encountered will not be recognized unless these difficulties could not have been foreseen, even though proper examination had been made.

Fabrication or ordering of any material or equipment prior to verification of site conditions shall be done at the contractor's risk.

All equipment and material shall be new and of first quality. Equipment and material shall be the same or equal to the basis of design

listed on these drawings.

Coordinate with all trades and verify all equipment rough—in items and locations with the equipment supplier or contractor. All re—wo

Coordinate with all trades and verify all equipment rough—in items and locations with the equipment supplier or contractor. All re—work and corrections required due to lack of coordination shall be the contractor's responsibility, and done at no cost to the owner.

Submit shop drawings and material data submittals to the engineer for approval before installation. No substitutions shall be allowed without prior approval by the engineer. Product data for piping, insulation, valves, specialties and all fixtures and equipment scheduled and specified here. For each submittal for review, allow 15 days excluding delivery time to and from the Contractor.

All equipment and flue materials shall be U.L. listed.

Installation shall comply with manufacturer requirements including all clearances recommended for proper operation of service. All serviceable parts shall be readily accessible.

Below ground sanitary drain and vent piping shall be solid—wall ASTM D2665 schedule 40 PVC. Install underground, PVC plastic drainage piping according to ASTM D2321. Above ground sanitary drain, roof drainage, overflow roof drainage, and vent piping shall be cellular—core ASTM F891 schedule 40 PVC. Install aboveground PVC piping according to ASTM D 2665.

All aboveground piping shall be adequately supported. Sanitary drain and vent piping shall have PVC Socket Fittings (ASTM D 2665, made to ASTM D 3311, drain, waste, and vent patterns and to fit Schedule 40 pipe). Slope pipe sizes 6" and under at 1/8 inch per foot continuously toward public sewer.

All above ground domestic water distribution piping shall be ASTM D 2846, SDR11, schedule 40 CPVC with socket fittings. All piping shall be adequately supported. Disinfect all domestic water piping after installation. All underground domestic water distribution piping 1" and smaller shall be ASTM D 876 & ASTM F 877 PEX with no fittings underground. All underground domestic water distribution piping 1-1/4" and larger shall be ASTM D 1785 schedule 40 PVC with ASTM D 2466 PVC socket fittings.

DOMESTIC WATER PIPING CLEANING

- A. Clean and disinfect potable domestic water piping as follows:
- 1. Purge new piping and parts of existing piping that have been altered, extended, or repaired before using.
- Use purging and disinfecting procedures prescribed by authorities having jurisdiction; if methods are not prescribed, use
 procedures described in either AWWA C651 or AWWA C652 or follow procedures described below:
- a. Flush piping system with clean, potable water until dirty water does not appear at outlets.
- b. Fill and isolate system according to either of the following:
- 1) Fill system or part thereof with water/chlorine solution with at least 50 ppm (50 mg/L) of chlorine. Isolate with valves and allow to stand for 24 hours.
- 2) Fill system or part thereof with water/chlorine solution with at least 200 ppm (200 mg/L) of chlorine. Isolate and allow to stand for three hours.
- c. Flush system with clean, potable water until no chlorine is in water coming from system after the standing time.
- d. Repeat procedures if biological examination shows contamination.
- e. Submit water samples in sterile bottles to authorities having jurisdiction.
- B. Prepare and submit reports of purging and disinfecting activities. Include copies of water—sample approvals from authorities having jurisdiction.
- C. Clean interior of domestic water piping system. Remove dirt and debris as work progresses.

Domestic water piping shall be insulated with Owens Corning type ASJ/SSL—II heavy density fiber glass with all service jacket. Insulation shall have a flame spread rating not to exceed 25 and a smoke density not to exceed 50 when tested in accordance with U.B.C. standard 42—1. Provide mastic on all joints and exposed ends of insulation. Insulate domestic Cold water piping in unconditioned spaces such as exterior corridors, attic, basements, etc with 1/2" thick insulation for piping 1—1/4" & smaller and 1" thick insulation for piping 1—1/2" & larger. Insulate all domestic Hot water supply and return piping with 1" thick insulation for piping 1—1/4" & smaller and 1—1/2" thick insulation for piping 1—1/2" & larger.

HW & CW Valves: Use pipe size valves, as shown below:

A. Ball: Watts LFFBV-3C.

B. Check: Watts #600 or #601S.

Fixture tailpieces, wall escutcheon, and traps for lavatories and sinks shall be brass tubing, semi—cast, or cast iron: All brass tubing shall be 17 gage, chrome plated. Grid drains for public lavatories.

Water Hammer Arresters shall comply with standard ASSE 1010, metal bellows type or copper piston type.

Lavatory Supports shall be type II, lavatory carrier with concealed arms and tie rod for wall—mounting, lavatory—type fixture. Include steel uprights with feet. For accessible—fixture support include rectangular steel uprights.

Lavatory/ Sink supply fittings: NSF Standard: Comply with NSF/ANSI 61 Annex G, "Drinking Water System Components — Health Effects," for supply—fitting materials that will be in contact with potable water. Standard: ASME A112.18.1/CSA B125.1. Supply Stops: Chrome—plated—brass, one—quarter—turn, ball—type valve with inlet connection matching supply piping. Wheel handle operation. Risers: Chrome—plated, soft—copper flexible tube for exposed applications and ASME A112.18.6, braided— or corrugated—stainless—steel, flexible hose for conceal behind cabinet applications.

Provide ADA Supply and Drain Protective Shielding Guards on ADA fixtures that piping is exposed. Supply and Drain Protective Shielding Guards shall comply with ICC A117.1 and Americans with Disabilities Act (ADA) requirements. Manufactured plastic wraps shall cover hot and cold water supplies, trap, and drain piping.

All pipe hangers, clamps and channels shall be adequately sized to carry pipe loads and prevent sagging.

All other materials not specifically described but required for a complete and proper installation of work of this section, shall be new, first quality of their respective kinds, and as selected by the contractor subject to acceptance by the engineer.

Lay out the plumbing system in careful coordination with the drawings, determining proper elevations for all components of the system and using only the minimum number of bends to produce a satisfactorily functioning system. Follow the general layout shown on the drawings in all cases except where other work may interfere. Unless shown otherwise, lay out all pipes to fall within partition, wall floor,

Do not cut into or reduce the size of any load—carrying member without the prior approval of the architect. Install all pipes to clear all beams and obstructions.

Permanently close and make weatherproof any openings or penetrations of the building envelope made for plumbing systems. All wall and floor penetrations shall be sleeved. All exterior wall or foundation wall penetrations shall use a mechanical seal.

Coordinate all roof penetrations with architectural plans and building and roofing trades.

or roof cavities, and to not require furring other than as shown on the drawings.

Provide shut-off balls valves and unions at all water connections to equipment and appliances.

Isolate all dissimilar metals with "EPCO" dielectric unions, except for brass or bronze valves with steel pipe.

Protect the potable water supply against backflow and siphonage from equipment, fixtures, etc., using approved backflow and anti-siphon

Thoroughly clean all piping and equipment. Removing all dirt, rust, oil, and plaster.

Test Sanitary drainage piping by plugging all openings and filling with water to a height equal to a 10 foot head. Allow to stand one hour or longer as required. Repair leaking joints and then re—test.

No work shall be covered until it has been inspected and accepted by the local authority.

Domestic water piping tests: Fill domestic water piping. Check components to determine that they are not air bound and that piping is full of water. Test for leaks and defects in new piping and parts of existing piping that have been altered, extended, or repaired. Leave new, altered, extended, or replaced domestic water piping uncovered and unconcealed until it has been tested and approved. Expose work that was covered or concealed before it was tested. Cap and subject piping to static water pressure of 50 psig (345 kPa) above operating pressure, without exceeding pressure rating of piping system materials. Isolate test source and allow it to stand for four hours. Leaks and loss in test pressure constitute defects that must be repaired. Repair leaks and defects with new materials, and retest piping or portion thereof until satisfactory results are obtained.

The entire system shall be warranted for a period of one (1) year beginning with Owner's acceptance of the work. All labor and materials necessary to repair or replace the system, or portions thereof, during that time shall be warranted for a period of one (1) year from the repair or replacement.

Install piping in concealed locations, unless otherwise indicated and except in equipment rooms, and service areas. Install piping indicated to be exposed and piping in equipment rooms and service areas at right angles or parallel to building walls. Diagonal runs are prohibited unless specifically indicated otherwise. Install piping above accessible ceilings to allow sufficient space for ceiling panel removal. Install piping to permit valve servicing. Install piping at indicated slopes. Install piping free of sags and bends. Install fittings for changes in direction and branch connections. Install piping to allow application of insulation. Select system components with pressure rating equal to or greater than system operating pressure. Install escutcheons for penetrations of walls, ceilings, and floors. Verify final equipment

Confirm that millwork is constructed with adequate provision for the installation of counter top lavatories and sinks.

Seal fixtures to wall and floor surfaces with sealant, color to match fixture.

All vents thru roof (VTR) shall be offset a minimum of 10'-0" from all outside air intakes.

locations for roughing—in.

Provide a complete through penetration fire stopping assembly for fire resistance rated wall assemblies. The through penetration assembly must be listed by an approved third—party test agency (UL), and include the entire listed assembly with all notations. Refer to architectural drawings for fire wall locations.

Approved manufactures: (Items submitted shall be approved by architect and engineer. Architect and engineer reserve the right to reject

China Fixtures: American Standard, Kohler, Toto, Zurn, Sloan

any item substituted for basis of design item for any reason.)

Faucets: Delta, T&S Brass, Chicago Faucets, Zurn, Kohler, Grohe, Moen, Speakman, Symmons Supplies & Traps: Engineered Brass CO., Mcguire, Charlotte Pipe, Brasscraft, IPS, Watts, Zurn Flush Valves: Sloan, Delany, Zurn, American Standard Floor Drains & Cleanouts: Zurn, Jay R Smith, Proset, Watts, Mifab, Wade, Josam, Sioux Chief, Oatey Tankless Electric Water Heaters: A.O. Smith, Rheem, EEmax, Chronomite

Toilet Seats: Bemis, Centoco, Church Seats, Olsonite, Beneke, Zurn, Mainline

ADA Protective Shielding Pipe Covers: Engineered Brass, McGuire, Plumberex, TRUEBRO, Zurn, Oatey


Fixture Supports: MIFAB, Jay R. Smith, Wade, Watts, Zurn

Water Hammer Arresters: AMTROL, Josam, MIFAB, PPP, Sioux Chief, Jay R. Smith, Wade, Watts, Zurn Brass Valves: American, Crane, Watts, Apollo

Wall Hydrants/ Hose Bibbs: MIFAB, Jay R. Smith, Wade, Watts, Woodford, Zurn

		1				l		
#	FIXTURE TYPE		STE FIXTURE CONN.	COLD	SUPPLY HOT	WATER F	IX. CONN. HOT	MANUFACTURE AND NOTES
WC1	WATER CLOSET 1.28 GPF	3"	3"	1"		1"		KOHLER K-96053 WATER CLOSET. SLOAN REGAL 111 SFSM-1.28 FLUSH VALVE. BEMIS 1655SSCT SEAT.
WC2	ADA WATER CLOSET 1.28 GPF	3"	3"	1"		1"		KOHLER K-96057-B WATER CLOSET. SLOAN REGAL 111 SFSM-1.28 FLUSH VALVE. BEN 1655SSCT SEAT.
UR1	URINAL 0.125 GPF	2**	2"	3/4"		3/4"		KOHLER K-5452-ET URINAL. SLOAN REGAL 186-0.125 FLUSH VALVE.
UR2	ADA URINAL 0.125 GPF	2**	2"	3/4"		3/4"		KOHLER K-5452-ET URINAL. SLOAN REGAL 186-0.125 FLUSH VALVE.
LAV	ADA WALL-HUNG LAVATORY 0.5 GPM	2**	1-1/4"	1/2"	1/2"	1/2"	1/2"	KOHLER K-2005 LAVATORY. MOEN 8413F05 FAUCET.
SHR1	SHOWER	2*	2"	1/2"	1/2"	1/2"	1/2"	BRADLEY WS-1WCA-6'-0"-HD-S15-AKV-LBJ-ST-SD-SHH-VS.
SHR2	ADA SHOWER	2"	2"	1/2"	1/2"	1/2"	1/2"	BRADLEY WS-1WCA-ADA-HD-ST-RSS-GB2-SB-SHH-VS.

			LEG	SEND			
\longrightarrow	SHUTOFF VALVE		COLD WATER	(TYP)	TYPICAL	VTR	VENT THRU ROOF
─	BALANCING VALVE		TEMPERED HOT WATER	C.T.	COUNTER-TOP	AFF	ABOVE FINISHED FLOOR
─ ✓	CHECK VALVE	——140°———	140° HOT WATER	DN	DOWN	CW	COLD WATER
<u> </u>	PIPE UP		HOT WATER RETURN	CONN.	CONNECTION	HW	HOT WATER
c—	PIPE DOWN	——	GAS	NTS	NOT TO SCALE	HWR	HOT WATER RETURN
PDI-B	PDI UNIT WATER HAMMER ARRESTOR	R	ROOF DRAINAGE PIPING	VT	VENT	B.F.F.	BELOW FINISH FLOOR
DWGS.	DRAWINGS		SEWER VENT	FFE	FINISHED FLOOR ELEVATION	CV	CLOSED VALVE
IW	INDIRECT WASTE		SEWER	FLR	FLR		
DS	DOWNSPOUT	с	CONDENSATE	GREASE	GREASE LADEN SEWER		
		0	OVERFLOW ROOF DRAINAGE PIPING				

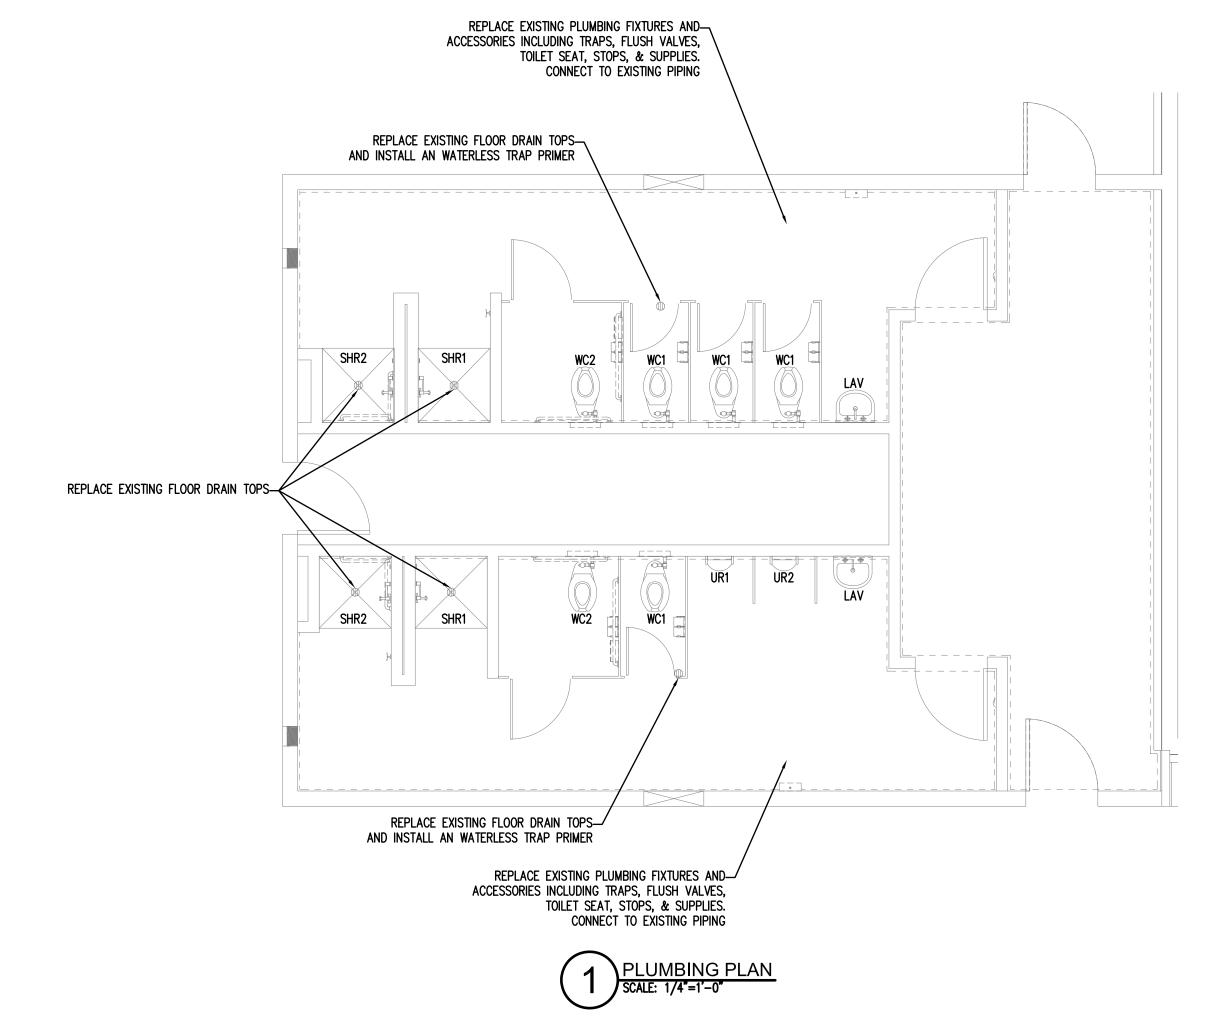



MACON-BIBB COUNTY PARKS AND RECREATION

RENOVATION PROJECT

MEMORIAL PARK REC. CENTER

2465 2ND ST, MACON, GA 31206

348 COTTON AVENUE

SUITE 500, PO BOX 110

MACON, GEORGIA 31201

169 New Street, Macon, GA 31201 (478)741-4632 - T.E. project # 24-082 www.totalengineers.com

These drawings information through the state of the state

These drawings convey certain contractual information through the use of color. Do NOT use drawings printed in black-and-white or greyscale.

© 2023, WMA Architects/Planners, Inc. d/b/a WM2A Architects .
These drawings, as instruments of service, remain the property of the Architect. Unauthorized use or reproduction is forbidden.

Project Status:

 Revision No (if any):
 Revision Date:

 Project No:
 Current Date:

 2024-079
 10/30/2024

2024-079 10/3

Drawing Name:
PLUMBING PLANS





ELECTRICAL SPECIFICATIONS

DIVISION 26

ELECTRICAL

SECTION A: GENERAL ELECTRICAL REQUIREMENTS

I. THESE PLANS AND SPECIFICATIONS APPLY TO MEMORIAL PARK REC. CENTER IN MACON, GEORGIA. THE WORK DESCRIBED BY THESE PLANS AND SPECIFICATIONS APPLY TO THE INDICATED PROJECT AND MAY NOT BE MODIFIED OR REUSED WITHOUT WRITTEN APPROVAL OF THE ENGINEER.

2. ALL WORK SHALL BE PERFORMED BY LICENSED ELECTRICAL CONTRACTOR WITH MINIMUM OF TWO YEARS OF EXPERIENCE. LIST OF PREVIOUS JOBS AND REFERENCES SHALL BE MADE AVAILABLE UPON REQUEST. CONTRACTOR SHALL PROVIDE ADEQUATE INSURANCE FOR PERSONNEL AND SHALL REPAIR ANY DAMAGE OCCURRING AS THE RESULT OF THIS PROJECT

SITE AND RELATED PROPERTY.

3. ALL WORK SHALL BE PERFORMED IN A PROFESSIONAL MANNER IN ACCORDANCE WITH THE 2020 NATIONAL ELECTRICAL CODE, LIFE SAFETY CODE NFPA IOI, ADA CODE, ALL ACCESSIBILITY CODES, STATE OF GEORGIA ENERGY CODE AND ALL OTHER APPLICABLE CODES AND ORDINANCES.

4. ALL PERMITS AND FEES SHALL BE OBATINED AND PAID FOR BY THE CONTRACTOR.

5. ALL EQUIPMENT, MATERIAL, AND DEVICES SHALL BE LISTED OR RECOGNIZED BY UNDERWRITER'S LABORATORY OR ELECTRICAL TESTING LABORATORY AND USED AND INSTALLED IN ACCORDANCE WITH IT'S LISTING.

6. ALL WORK PERFORMED SHALL BE WARRANTED FOR A PERIOD OF ONE YEAR FROM THE THE FINAL COMPLETION DATE EXCEPT FOR FUSES AND LAMPS IN LIGHT FIXTURES. UPON NOTIFICATION OF A PROBLEM, THE CONTRACTOR SHALL INVESTIGATE THE PROBLEM WITHIN 48 HOURS UNLESS A DIFFERENT TIME PERIOD IS AGREED TO. THE CONTRACTOR SHALL INVESTIGATE, REPAIR OR REPLACE ALL FAULTY EQUIPMENT WITHIN A REASONABLE TIME PERIOD WITHOUT CHARGE TO THE OWNER.

7. THE TERM "PROVIDE" SHALL BE UNDERSTOOD TO MEAN, OBTAIN THE ITEM DESCRIBED, INSTALL ITEM IN ACCORDANCE WITH THESE PLANS, SPECIFICATIONS, AND MANUFACTURER'S RECOMMENDATIONS.

8. ALL PENETRATIONS MADE IN FIRE RATED BUILDING PORTIONS SHALL BE SEALED WITH A LISTED RESISTANT MATERIAL SUITABLE FOR THE APPLICATION.

9. ALL INSTALLATIONS OF ELECTRICAL EQUIPMENT AND MATERIALS SHALL BE COORDINATED WITH OTHER TRADES PRIOR TO INSTALLATION.
10. PLANS ARE DIAGRAMMATIC AND SHOW THE LOCATION OF THE EQUIPMENT, RACEWAY AND FIXTURES, AND ARE NOT TO BE SCALED. ALL DIMENSIONS SHALL BE VERIFIED AT THE BUILDING SITE.

11. CONTRACTOR SHALL VERIFY AND COORDINATE ALL EQUIPMENT AND DEVICE LOCATIONS WITH OWNER'S PROJECT MANAGER PRIOR TO INSTALL ATION

WITH OWNER'S PROJECT MANAGER PRIOR TO INSTALLATION. 12. EQUIPMENT POWER SUPPLY AND WIRING REQUIREMENTS; THE CONTRACTOR SHALL SUBMIT FOR REVIEW A TABULATED SHEET OF EQUIPMENT POWER SUPPLY AND WIRING REQUIREMENTS FOR ALL MECHANICAL EQUIPMENT REQUIRING POWER AS SPECIFIED IN DIVISION 23. REQUIREMENTS SHALL BE IDENTIFIED BY HORSEPOWER OR KW, OPERATING AMPERAGE, REQUIRED VOLTAGE AND PHASE REQUIREMENTS, AND MANUFACTURERS SUGGESTED OVERCURRENT CIRCUIT PROTECTION DEVICE SIZE AND MINIMUM CIRCUIT AMPACITY SIZE. WHERE THE ELECTRICAL REQUIREMENTS SUBMITTED FOR MECHANICAL EQUIPMENT DIFFERS FROM THE BRANCH CIRCUITRY SHOWN ON THE ELECTRICAL DRAWINGS (WHEN USING THE BASIS OF DESIGN UNIT LISTED IN THE MECHANICAL SCHEDULES/SPECIFICATIONS OR A SIMILAR UNIT OF THE SAME SIZE FROM LISTED ALTERNATE MANUFACTURERS), THE CONTRACTOR SHALL MAKE THE NECESSARY ADJUSTMENTS TO THE BRANCH CIRCUITRY PER THE CURRENT NEC AT NO ADDITIONAL COST O THE OWNER. WHEN CHANGES ARE MADE TO POWER REQUIREMENTS FOR EQUIPMENT DUE O OWNER.ARCHITECT/ENGINEER APPROVED VALUE ENGINEERING CHANGES TO EQUIPMENT, HE COST MUST NE INCLUDED IN THE VALUE ENGINEERING OVERALL CHANGE ORDER COST COSTS DUE TO ADJUSTMENTS IN BRANCH CIRCUITRY TO EQUIPMENT DUE TO VALUE ENGINEERING CHANGES WILL NOT BE ALLOWED AFTER THE OVERALL VALUE ENGINEERING CHANGE ORDER HAS BEEN APPROVED. IN ALL CASES, POWER WIRING REQUIREMENTS FOR MECHANICAL EQUIPMENT MUST BE PROVIDED TO THE ENGINEER BEFORE OR AT THE SAME TIME AS THE SHOP DRAWINGS FOR THE ELECTRICAL DISTRIBUTION GEAR OR EQUIPMENT. IN NO CASE SHALL THE ELECTRICAL DISTRIBUTION GEAR OR EQUIPMENT BE ORDERED OR BRANCH CIRCUITRY ROUGHED IN PRIOR TO ENGINEER REVIEW AND COMMENT ON THIS

SECTION B: BASIC MATERIALS

I. ALL CONDUCTORS USED FOR 600 VOLTS OR LESS SHALL BE HIGH GRADE COPPER CONDUCTORS WITH 75 DEGREE C, THHN OR THWN THERMOPLASTIC INSULATION. ALL CONDUCTORS SHALL BE MADE IN THE USA. ALL CONDUCTORS ROUTED IN UNDERGROUND CONDUIT SHALL BE RATED FOR WET LOCATIONS.

2. ALL INTERIOR 120 VOLT, 20 AMP POWER AND LIGHTING WIRING SHALL BE INSTALLED IN "MC" CABLE (IF NOT EXPOSED) FOR ALL INTERIOR CIRCUITS UNLESS OTHERWISE NOTED. POWER CIRCUITS FOR HVAC EQUIPMENT SHALL BE IN ELECTRICAL METALIC CONDUIT. ALL CONDUIT SHALL BE SUPPORTED FROM BUILDING STRUCTURE. IT SHALL NOT BE SUPPORTED FROM DUCTWORK, PIPING, CEILING GRID OR CEILING GRID SUPPORTS, OR ANY OTHER NON-STRUCTURAL ITEM. CONDUIT SHALL BE SUPPORTED IN ACCORDANCE WITH THE NEC. CONDUIT IN EXPOSED STRUCTURE AREAS SHALL BE EMT. GALVANIZED RIGID STEEL CONDUIT SHALL BE USED IN AREAS WHERE IT WILL BE EXPOSED TO PHYSICAL DAMAGE. ALL 20A BRANCH CIRCUITS LONGER THAN 80FTSHALL BE

DOCUMENT. ANY EQUIPMENT ORDERED OR BRANCH CIRCUITRY ROUGHED IN ON THE JOBSITE WITHOUT THIS REVIEW AND COMMENT WILL BE TOTALLY AT THE CONTRACTORS RISK.

3. CONDUIT UNDERGROUND SHALL BE SCHEDULE 40 PVC. IF MORE THAN ONE CONDUIT IS PROVIDED IN A SINGLE TRENCH, THE CONDUIT SHALL BE RACKED WITH SPACERS EVERY FOUR FEET TO MAINTAIN A MINIMUM SPACING BETWEEN CONDUIT OF TWO INCHES. BACKFILL USED FOR UNDERGROUND INSTALLATIONS SHALL BE FREE OF FOREIGN MATTER. WHERE EXPOSED TO WEATHER, CONDUIT SHALL BE GALVANIZED RIGID STEEL OR INTERMEDIATE METALLIC CONDUIT. THE CONDUIT SHALL BE TERMINATED WITH LISTED FITTINGS AND ALL CONDUIT ENDS SHALL BE REAMED AND SMOOTH. ALL CONDUIT ENDS IN BOXES SHALL BE PROVIDED WITH INSULATED BUSHINGS.

4. A #12 INSULATED COPPER GROUND CONDUCTOR SHALL BE INCLUDED IN ALL BRANCH CIRCUITS RATED 20 AMPERES. ALL OTHER CIRCUITS AND FEEDERS WILL BE PROVIDED WITH AN INSULATED COPPER CONDUCTOR SIZED AS NOTED OR IN ACCORDANCE WITH THE NEC, WHICHEVER IS GREATER.

5. THE MINIMUM SIZE OF ALL CONDUCTORS NOT OTHERWISE INDICATED IS #12 AND THE MINIMUM SIZE OF ALL CONDUIT UNLESS OTHERWISE INDICATED IS 1/2 IN.

6. ALL JUNCTION BOXES SHALL BE PROVIDED WITH COVERS AND ALL UNUSED OPENINGS

SHALL BE PLUGGED. ALL JUNCTION BOXES SHALL BE INDEPENDENTLY SUPPORTED FROM STRUCTURE. COVERS OF BOXES SHALL BE LABELED WITH THE CIRCUIT NUMBER WITH A BLACK PERMANENT MARKER IN 3/4 IN. HIGH LETTERS (LEGIBLE HANDWRITTEN LETTERING IS ACCEPTABLE).

7. ALL OUTLET BOXES SHALL BE SQUARE METAL BOXES. PROVIDE PLASTER RINGS FOR ALL OUTLET BOXES CONTAINING DEVICES TO PROVIDE A FIRM MOUNTING SUPPORT FOR THE

8. ALL CONVENIENCE RECEPTACLES SHALL BE SPECIFICATION GRADE 20 AMP RECEPTACLES, OWNER TO SELECT COLOR.

9. ALL LIGHT SWITCHES SHALL BE SPECIFICATION GRADE 20 AMP TOGGLE SWITCHES FULL LOAD RATED FOR TUNGSTEN-HALOGEN LAMPS, OWNER TO SELECT COLOR.

10. PROVIDE FACEPLATES FOR ALL RECEPTACLES AND SWITCHES. COORDINATE STYLE AND COLOR WITH OWNER'S PROJECT MANAGER.

11. PROVIDE BETWEEN 12 AND 24 INCHES OF LIQUID TIGHT FLEXIBLE CONDUIT BETWEEN

BE SUPPORTED TO PREVENT THE CONDUIT FROM RESTING ON THE GROUND OR CONCRETE PAD.

12. PROVIDE WEATHERPROOF RECEPTACLE WITHIN 25 FEET OF EACH PIECE OF EXTERIOR EQUIPMENT. THIS RECEPTACLE SHALL BE MOUNTED HORIZONTALLY WITH METAL HINGED "IN USE" COVER MOUNTED TO OPEN UP. THIS OUTLET SHALL BE A GFCI RECEPTACLE. THIS RECEPTACLE SHALL BE BE MOUNTED IN DIE CAST NON CORRODING METAL BOX.

13. WHEN OUTLETS OR BOXES ARE INDICATED INSTALLED ON OPPOSITE SIDES OF THE SAME WALL. THE CONTRACTOR SHALL ADJUST THE LOCATION TO OFFSET THE OUTLETS

RIGID CONDUIT AND ANY EQUIPMENT CONTAINING MOTORS. THE FLEXIBLE CONDUIT SHALL

SECTION C: LIGHTING

WITH A WALL STUD PROVIDING SEPERATION.

SCHEDULE ON THE PLANS. ALL LIGHT FIXTURES SHALL BE PROVIDED WITH LAMPS, DRIVERS, BALLASTS, AND FULLY FUNCTIONING AT COMPLETION OF PROJECT.

2. ALL LED FIXTURES SHALL BE U.L. LISTED AND HAVE A MINIMUM OF 5 YEAR ON-SITE REPLACEMENT WARRANTY FOR DEFECTIVE OR NON-STARTING LED SOURCE ASSEMBLIES, DRIVERS, AND FOR LUMINAIRES EXHIBITING INADEQUATE LUMEN OUTPUT. IT SHALL COVER MATERIAL, FIXTURE FINISH, WORKMANSHIP, AND SHIPPING. ON-SITE REPLACEMENT SHALL INCLUDE TRANSPORTATION, REMOVAL, AND INSTALLATION OF NEW FIXTURE.

3. RATED LUMINAIRE WATTAGE SHALL BE ACTUAL, ACCOUNTING FOR ANY REDUCTION IN EFFICIENCY DUE TO SUB-OPTIMAL LOADING OF DRIVERS.

4. DRIVERS SHALL BE CAPABLE OF ACCEPTING THE VOLTAGE INDICATED ON THE LIGHTING FIXTURE SCHEDULE AND CAPABLE OF DIMMING IF REQUIRED. DRIVERS SHALL HAVE A CLASS

TYPES AND SPECIFIC REQUIREMENTS ARE PROVIDED ON THE LIGHTING FIXTURE

FIXTURE SCHEDULE AND CAPABLE OF DIMMING IF REQUIRED. DRIVERS SHALL HAVE A CLASS A RATING, TOTAL HARMONIC DISTORTION OF LESS THAN 20%, AND SHALL NOT CONTAIN ANY POLYCHLORINATED BIPHENYL (PCB).

5. ALL LED FIXTURES SHALL BE TESTED TO IES LM-79 AND IES LM-80 STANDARDS. OUTDOOR FIXTURES SHALL BE IP65 RATED. LED'S, DRIVERS AND ALL COMPONENTS SHALL HAVE A SYSTEM LIFETIME OF 50,000 HOURS OR MORE AT 25 DEGREES CELSIUS AND SHALL

HAVE A SYSTEM LIFETIME OF 50,000 HOURS OR MORE AT 25 DEGREES CELSIUS AND SHAL MAINTAIN A MINIMUM OF 85% OF INITIAL LUMEN OUTPUT AFTER 55,000 HOURS OF OPERATION. LED'S SHALL HAVE COLOR RENDERING INDEX (CRI) OF 80 OR GREATER.

6. ALL SURFACE MOUNTED FIXTURES SHALL BE INDEPENDENTLY SUPPORTED FROM STRUCTURE. ALL CEILING MOUNTED FIXTURES SHALL BE SUPPORTED FROM STRUCTURE

7. ALL LENSES ON FIXTURES SHALL BE 0.125 INCH THICK MINIMUM. ALL HOUSINGS SHALL BE 22 GAUGE STEEL MIN. AND HAVE A POST FABRICATION HIGH REFLECTIVE WHITE FINISH.

SECTION D: TELEPHONE/DATA SYSTEMS (RACEWAY ONLY)

MODULAR JACKS. PROVIDE PULL STRING IN ALL EMPTY CONDUITS.

AND BRACED TO PREVENT MOVEMENT IF IMPACTED.

WORK INCLUDED:

I. PROVIDE IIN. EMT FROM EACH OUTLET TO ABOVE 12 INCHES ABOVE ACCESSIBLE CEILING. PROVIDE 4 IN. SQUARE BACKBOX WITH SINGLE GANG PLASTER RING FOR EACH TV/TELEPHONE/DATA OUTLET. ALL CONDUIT SHALL BE CONCEALED. PROVIDE FACEPLATE WITH

	LIGHTING FIXTURE SCHEDU	LE
'PΕ	DESCRIPTION	MANUFACTURER
А	I'X4' LINEAR VAPORTIGHT FIXTURE; SURFACE OR SUSPENDED MOUNTING; FIBERGLASS AND NEMA 4X RATED LENS AND HOUSING; WET AND IP RATED .	LITHONIA "FEM LED" SER.COLUMBIA LXEM , PORTFOLIO "LD6"
	LAMPS: LED, 6000 LUMENS, 46 WATTS, 3500 DEGREE K DRIVER: UNV. VOLT	SER., CREE "SDL6" SER.
ОА	BUILDING YOKE MOUNTED FLOODLIGHT WITH DIE-CAST ALUMINUM HOUSING; UL LISTED FOR WET LOCATION. PROVIDED WITH PHOTOCELL FOR DUSK TILL DAWN OPERATION.	LITHONIA ESXFI ALO OR APPROVED EQUAL.
	LAMPS: LED, 3000 LUMENS, 19 WATTS, 4000 DEGREE K DRIVER: UNV. VOLT DRIVER	
OB	LED AREA LIGHT, DIE-CAST ALUMINUM HOUSING, PRECISION ACRYLIC REFRACTIVE LENS; ALUMINUM HEAT SINC; WET LOCATION LISTED. WIDE DISTRIBUTION WITH FORWARD THROW OPTICS. PROVIDE DOUBLE BULLHORN BRACKET COMPATIBLE WITH EXISTING POLE. COLOR SELECTION BY ARCHITECT.	LITHONIA "RSXI" SER., BEACON "VIPER" SER., LUMARK "PRV" SER., CREE "OSQ MEDIUM" SER.
	LAMPS: LED, 15560 LUMENS, 113 WATTS, 4000 DEGREE K DRIVER: UNV. VOLT DRIVER	JLIV.
-⊗	LED ALUMINUM EXIT, DIE-CAST HOUSING; UNIVERSAL MOUNTING STANDARD.(PROVIDE 90 MIN. BACK-UP BATTERY).	LITHONIA "LQC" SER., DUAL-LITE "SE" SER, SURELITES "CX"
	LAMPS: LED BALLAST:UNV. VOLT	SER., EVENLITE "CCDS" SER.

NOTES:
I. CONTRACTOR TO VERIFY ALL VOLTAGES, GRID AND CEILING TYPES WITH THE ARCHITECT AND COORDINATE FIXTURE DIMENSION SIZE TO ENSURE A PROPER FIT IN ALL CEILING TYPES PRIOR TO ORDERING.

2. ALL LUMENS LISTED ARE DELIVERED LUMENS. ALL EQUALS TO SPECIFIED FIXTURES SHALL NOT BE ANY LOWER THAN 5% OF SPECIFIED LUMENS. WATTAGE SHALL NOT BE HIGHER THAN 15% OF SPECIFIED WATTAGE.

3. LISTING OF MANUFACTURERS DOES NOT EQUAL AUTOMATIC APPROVAL. ALL CHARACTERISTICS NOTED IN DESCRIPTION SECTION MUST BE MET IN ORDER TO BE APPROVED. WHERE VENDOR/REP. DOES NOT HAVE ONE MANUFACTURER LISTED, PRIOR APPROVAL IS REQUIRED TO BE SUBMITTED TO ENGINEER TEN (10) DAYS PRIOR TO BID.

4. PROVIDE UNSWITCHED HOT TO EXIT SIGNS, EMERGENCY FLOOD LIGHTS AND EXTERIOR BUILDING EGRESS

GENERAL NOTES:

- A. ALL FLUSH RECESSED OUTLET BOXES SHALL BE INSTALLED SUCH THAT FRONT EDGE OF THE BOX WILL NOT BE SET BACK OF THE FINISHED SURFACE MORE THAN 1/4 IN. IN ORDER TO COMPLY WITH N.E.C. 314-20. SUPPORT OF OUTLET BOX BY RECEPTACLE AND COVERPLATE IS NOT ACCEPTABLE. CAREFULLY COORDINATE ROUGH-IN WITH BLOCK MASONS AND GROUT-IN CELL CONTAINING OUTLET BOX.
- B. DO NOT SCALE DRAWINGS TO LOCATE EQUIPMENT OR OUTLETS.

 MOUNTING HEIGHTS AS INDICATED ON THE DRAWINGS SHALL BE
 FROM THE FINISHED FLOOR TO THE CENTER LINE OF THE OUTLET
 BOX.
- C. THE ELECTRICAL DRAWINGS ARE ONLY A PART OF THE CONTRACT DOCUMENTS. ALL OF THE DRAWINGS AND SPECIFICATIONS MUST BE REVIEWED FOR THEIR INTERRELATIONSHIP AND REQUIRED COORDINATION BETWEEN DISCIPLINES.

PROVIDE ALL BRANCH CIRCUIT CONDUIT/CONDUCTORS AS NECESSARY TO CONNECT ALL DEVICES SHOWN ON THE CIRCUIT. PROVIDE DEDICATED NEUTRALS FOR ALL CIRCUITS

ELECTRICAL LEGEND	
LIGHTING AND POWER	
	CONDUIT RUN CONCEALED ABOVE CEILING OR IN WALL, HASH MARKS INDICATE NUMBER OF CONDUCTORS. (3 WIRE UNLESS SHOWN)
\-\ \\ \	CONDUIT RUN CONCEALED BELOW FLOOR SLAB, OR UNDERGROUND.
A-2,4	HOMERUN TO PANELBOARD, LETTER OR LETTERS INDICATE PANELBOARD. NUMBERS INDICATES CIRCUIT NUMBERS.
0	LIGHT FIXTURE, SEE SCHEDULE FOR MOUNTING AND TYPE.
9	LIGHT FIXTURE, SEE SCHEDULE FOR MOUNTING AND TYPE.PROVIDE WITH 1100 LUMEN, 90 MINUTE BATTERY PACK.
⊢	LIGHTING FIXTURE, WALL BRACKET MOUNTED. (SEE ARCHITECTURAL FOR MOUNTING HEIGHT.)
WP 	DUPLEX CONVENIENCE OUTLET, GFITYPE.18 IN. MOUNTING HEIGHT. "WP" WHERE SHOWN INDICATES WEATHERPROOF. PROVIDE METAL IN-USE WEATHERPROOF COVERPLATE.
₩	DUPLEX CONVENIENCE OUTLET, GFI TYPE. MOUNTED ABOVE COUNTER. MOUNT AT 3 FT 4 IN. TO BOTTOM OF BOX.
ķ ₃	KEY THREE OR FOUR WAY SWITCH AS INDICATED. 42 IN. A.F.F. MOUNTING HEIGHT.
ķ	KEY SWITCH TO USE "CYLINDER" TYPE KEY. 42 IN. A.F.F. MOUNTING HEIGHT.
_	PANELBOARD, SEE SCHEDULE.
LIGHTING CONTROL SENSORS	
3 _{EX}	OCCUPANCY SENSOR, EXISTING TO REMAIN.
TELEPHONE SYSTEM (RACEWAY, BOXES AND PULL STRINGS ONLY)	
•	TELEPHONE OUTLET, FLUSH WALL MOUNTED AT 18 IN. TO CENTER LINE OF OUTLET
TB	PLYWOOD BACKBOARD, "TB" INDICATES TELEPHONE BOARD.

I. ALL MOUNTING HEIGHTS ARE FROM FINISHED FLOOR TO CENTERLINE OF OUTLET OR DEVICE.
2. ALL RECEPTACLES SHALL BE TAMPER RESISTANT (TYPE "TR").

KEYED NOTES: (THIS SHEET ONLY)

- EXISTING ELECTRICAL LIGHTING FIXTURES TO BE REPLACED IN SAME LOCATION.
 REUSE EXISTING BRANCH CIRCUIT SERVING EXISTING LIGHTING FIXTURES.

 2 EXTEND TELEPHONE CABLING TO EXISTING TELEPHONE HEAD END EQUIPMENT.
 FIELD LOCATE LOCATION OF EXISTING HEAD END EQUIPMENT LOCATION PRIOR TO
- NEW LIGHTING FIXTURE WITH NEW BATTERY PACK IS TO REPLACE EXISTING
- LIGHTING FIXTURE WITH BATTERY PACK. INSURE TO CIRCUIT IN SAME MANNER AS EXISTING LIGHTING FIXTURE.
- COORDINATE EXACT LOCATION AND MOUNTING HEIGHT WITH ARCHITECT PRIOR TO ROUGH-IN. LIGHTING FIXTURE PROVIDED WITH PHOTOCELL, SEE LIGHTING FIXTURE SCHEDULE.
- PROVIDE AN UNSWITCHED HOT. ENSURE NOT TO EXCEED ALLOWABLE WATTAGE FOR BRANCH CIRCUIT.

 6 ELECTRICAL ITEMS NOT SHOWN (SMOKE DETECTORS, ETC.) SHALL REMAIN AND BE

5> CIRCUIT LIGHTING FIXTURE TO NEAREST EXISTING LIGHTING BRANCH CIRCUIT.

PROTECTED DURING CONSTRUCTION.


EXISTING POOL SITE LIGHTING TO BE REPLACED WITH NEW LIGHTING FIXTURE(S). SITE LIGHTING POLE IS EXISTING TO REMAIN. UTILIZE EXISTING BRANCH CIRCUIT(S) AND EXISTING CONTROL METHOD TO SERVE NEW LIGHTING FIXTURES. PROVIDE DOUBLE BULLHORN FOR MOUNTING NEW LIGHTING FIXTURES ON TOP OF EXISTING


GENERAL NOTES:

- A. PROVIDE UNSWITCHED HOT CONDUCTOR TO ALL EMERGENCY AND EXIT LIGHTS.
- B. FIRE SEAL ALL FIREWALL PENETRATIONS.

EXISTING LEGEND

EX EXISTING DEVICE TO BE REPLACED WITH NEW INCLUDING FACEPLATE.

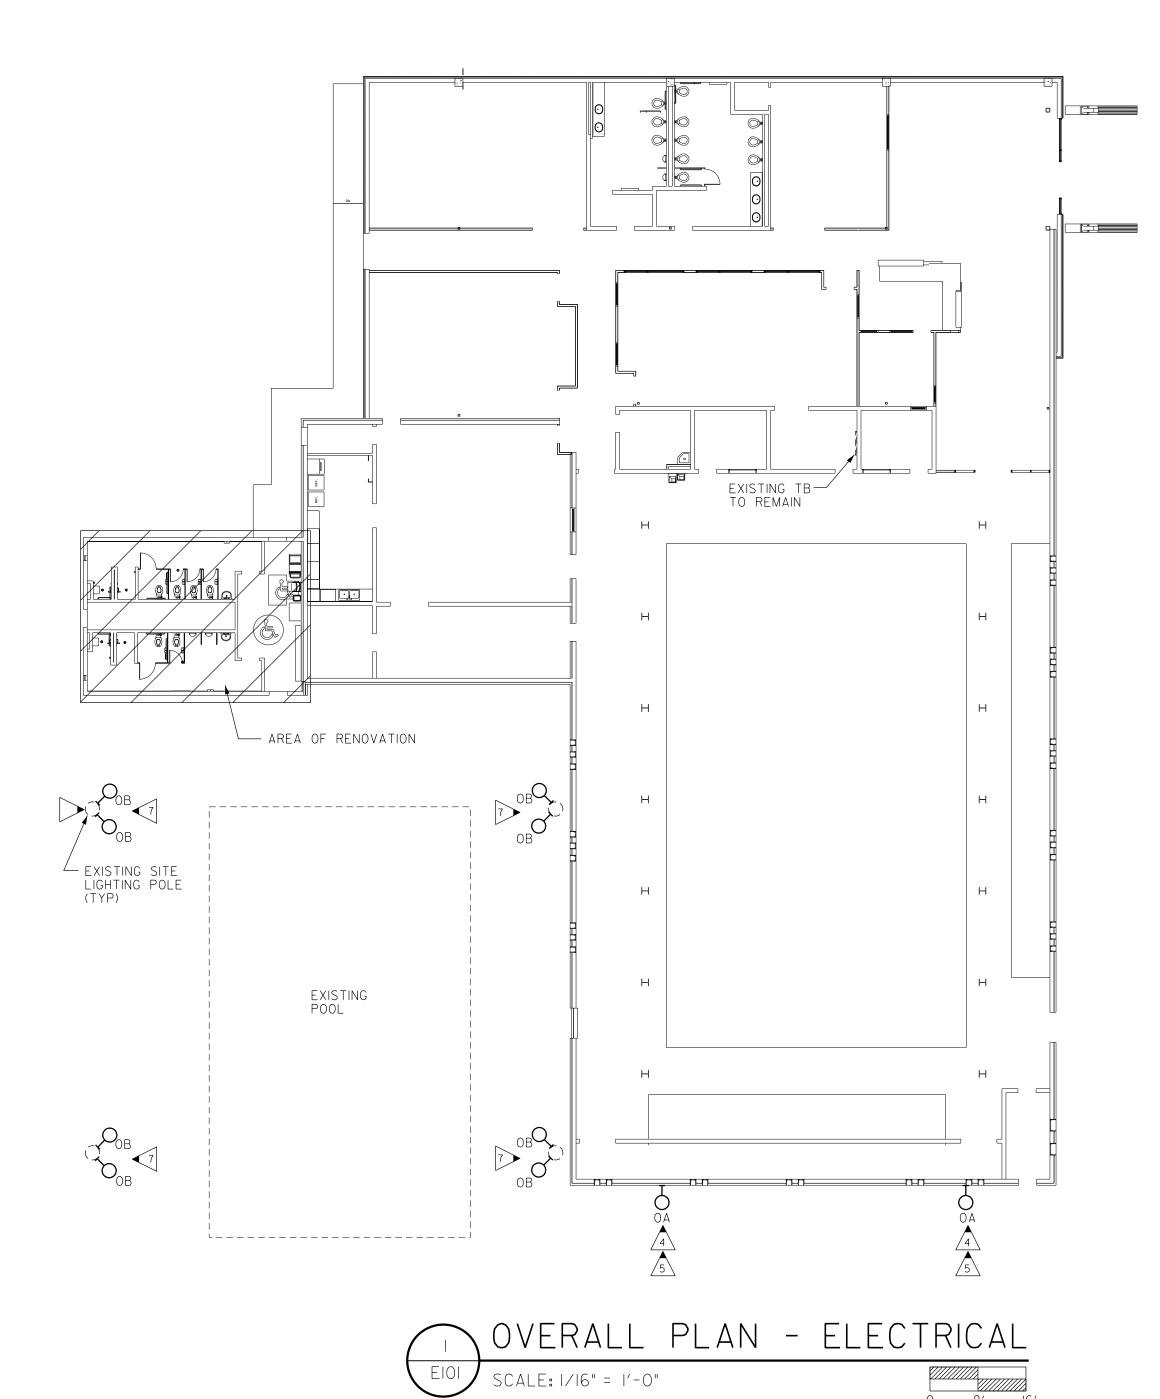


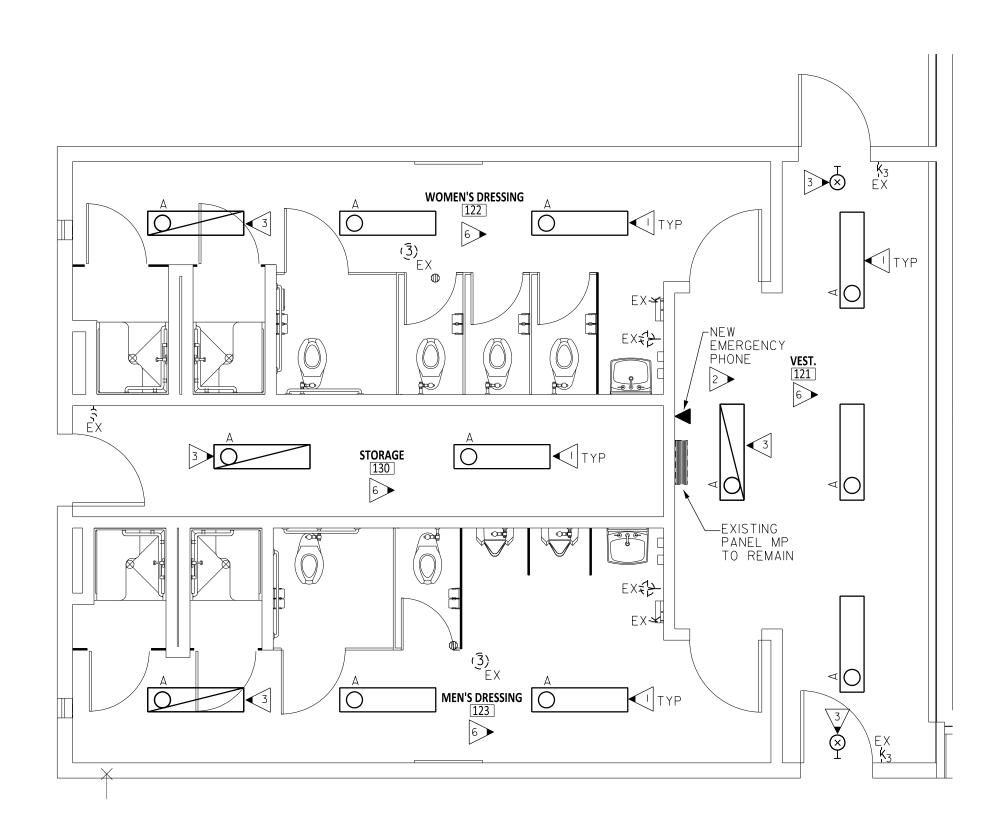





ARCHITECTS
WM2A.COM
348 COTTON AVENUE
SUITE 500, PO BOX 110
MACON, GEORGIA 31201

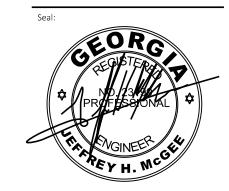



MACON-BIBB COUNTY
PARKS AND RECREATION

MEMORIAL PARK REC. CENTER
RENOVATION PROJECT

2465 2ND ST, MACON, GA 31206

These drawings convey certain contractual information through the use of color. Do NOT use drawings printed in black-and-white or greyscale.

© 2023, WMA Architects/Planners, Inc.

These drawings, as instruments of service, remain the property of the Architect.
Unauthorized use or reproduction is forbidden.

Project Status:

ISSUED FOR PERMIT

Pavision No (if anyl): Revision Date:

d/b/a WM2A Architects .

Project No: Current Date: 2024-079 10/30/24

Drawing Name:

FLOOR PLAN -ELECTRICAL